

RESOLUTION NO. 81-2021

A RESOLUTION OF THE CITY COUNCIL OF THE CITY OF MESQUITE, TEXAS, APPROVING THE TERMS AND CONDITIONS OF THE SEVENTH AMENDMENT TO THE COMMUNICATIONS FACILITIES LICENSE WITH CELLCO PARTNERSHIP D/B/A VERIZON WIRELESS (“LICENSE AGREEMENT”), TO AMEND THE SITE PLAN TO REFLECT UPDATED EQUIPMENT LOCATED ON THE CITY’S SERVICE CENTER COMMUNICATIONS TOWER, AS SPECIFIED IN THE LICENSE AGREEMENT; AND AUTHORIZING THE CITY MANAGER TO EXECUTE AND ADMINISTER THE LICENSE AGREEMENT ON BEHALF OF THE CITY.

WHEREAS, the City of Mesquite (the “City”) and Dallas MTA, L.P., d/b/a Verizon Wireless entered into a Communications Facilities License on October 13, 1997 (the “Agreement”); and

WHEREAS, the Agreement was previously amended on June 5, 2012, March 19, 2015, July 30, 2015, July 18, 2017, March 7, 2018, and December 3, 2018, and

WHEREAS, Dallas MTA, L.P., d/b/a Verizon Wireless was dissolved by operation of law effective December 31, 2018, and its assets and liabilities, including the Agreement, were redistributed to Cellco Partnership d/b/a Verizon Wireless (“Licensee”); and

WHEREAS, Licensee is requesting a seventh amendment to the Agreement that will allow Licensee to amend the site plan to reflect updated equipment located on the City’s Service Center Communications Tower.


NOW, THEREFORE, BE IT RESOLVED BY THE CITY COUNCIL OF THE CITY OF MESQUITE, TEXAS:

SECTION 1. That the terms and conditions of the Seventh Amendment to Communications Facilities License (the “Amendment”), attached hereto as Exhibit A, are found to be acceptable and in the best interest of the City and its citizens, and are hereby approved.

SECTION 2. That the City Manager is hereby authorized to finalize and execute the Amendment and all other documents necessary to consummate the transactions contemplated by the Amendment.

SECTION 3. That the City Manager is further hereby authorized to administer the Agreement, as amended, on behalf of the City including, without limitation, the City Manager shall have the authority to: (i) provide any notices required or permitted by the Agreement; (ii) approve minor amendments to the Agreement provided such amendments do not change either party’s use of the property or change the rent charged; (iii) exercise any rights and remedies available to the City under the Agreement; and (iv) execute any notices, amendments, approvals, consents, denials, and waivers authorized by the Agreement.

DULY RESOLVED by the City Council of the City of Mesquite, Texas, on the 6th day of  
December 2021.

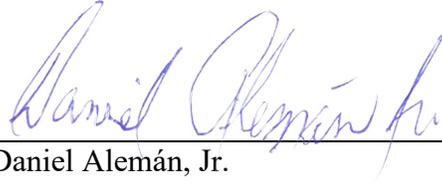

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Daniel Alemán, Jr.  
Mayor

ATTEST:



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Sonja Land  
City Secretary

APPROVED AS TO LEGAL FORM:



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David L. Paschall  
City Attorney

**EXHIBIT A**

**SEVENTH AMENDMENT TO THE  
COMMUNICATIONS FACILITIES LICENSE AGREEMENT**

**BETWEEN**

**THE CITY OF MESQUITE, TEXAS, AND  
CELLCO PARTNERSHIP d/b/a VERIZON WIRELESS**

APPROVED BY CITY COUNCIL  
DATE 12.6.2021  
AGENDA ITEM NO. 10

Licensee Site Name: Samuel Park  
Licensee Contract No.: 25519

## SEVENTH AMENDMENT TO COMMUNICATIONS FACILITIES LICENSE

This SEVENTH AMENDMENT TO COMMUNICATIONS FACILITIES LICENSE ("**Seventh Amendment**"), dated as of the Effective Date (as hereinafter defined), is by and between the **City of Mesquite**, a Texas home rule municipality, having a mailing address of 1515 N. Galloway Avenue, Mesquite, TX 75149 ("**City**") and **Cellco Partnership d/b/a Verizon Wireless**, having a principal office located at One Verizon Wireless Way, Mail Stop 4AW100, Basking Ridge, New Jersey 07920 ("**Licensee**").

WHEREAS, City and Dallas MTA, L.P. d/b/a Verizon Wireless entered into a Communications Facilities License dated October 13, 1997, whereby City licensed to Licensee use of certain premises therein described that are a portion of the premises owned by the City located at 1101 E. Main Street, Mesquite, Texas 75149 (the "**Original License Agreement**"); and

WHEREAS, the Original License Agreement has been amended by: (i) the First Amendment to Communications Facilities License dated as of June 5, 2012 ("**First Amendment**"); (ii) the Second Amendment to Communications Facilities License dated as of March 19, 2015 ("**Second Amendment**"); (iii) the Third Amendment to Communications Facilities License dated as of July 30, 2015 ("**Third Amendment**"); (iv) the Fourth Amendment to Communications Facilities License dated as of July 18, 2017 ("**Fourth Amendment**"); (v) the Fifth Amendment to Communications Facilities License dated March 7, 2018 ("**Fifth Amendment**"); and (vi) the Sixth Amendment to Communications Facilities License dated March 5, 2019 ("**Sixth Amendment**"); and

WHEREAS, the Original License Agreement, as amended by the First Amendment, the Second Amendment, the Third Amendment, the Fourth Amendment, the Fifth Amendment, and the Sixth Amendment are collectively referred to in this Seventh Amendment as the "**Agreement**"; and

WHEREAS, all capitalized terms used in this Seventh Amendment but not defined herein have the same meanings as defined in the Agreement; and

WHEREAS, pursuant to Assistant Secretary's Certificate dated January 14, 2019, Dallas MTA, L.P. was dissolved by operation of law effective December 31, 2018 and its assets and liabilities redistributed to Cellco Partnership; and

WHEREAS, the City and Licensee desire to further amend the Agreement as more fully set forth herein.

NOW THEREFORE, in consideration of the foregoing and other good and valuable consideration, the receipt and sufficiency of which are hereby acknowledged, City and Licensee agree as follows:

1. **Amendment of Site Plan.** The SITE PLAN attached as Attachment A-2(B) to the Sixth Amendment is hereby deleted and replaced with **Attachment A-2(C)**, attached hereto and incorporated herein by reference. As of the Effective Date, all references in the Agreement to Attachment A-2, Attachment A-2(A), and Attachment A-2(B) are references to Attachment A-2(C).

2. **Amendment of Equipment Compound and Antenna Facilities.** The list of Equipment and Compound Facilities attached as Attachment B-5 to the Sixth Amendment is hereby deleted and replaced with **Attachment B-6**, attached hereto and incorporated herein by reference. As of the Effective Date, all references in the Agreement to Attachments B, B-1, B-2, B-3, B-4, and B-5 are references to Attachment B-6.

3. **Equipment.** From and after the Effective Date, the City agrees that Licensee may install the equipment described in Attachment B-6 on the Premises.

4. **Permitted Antenna Facilities and Equipment.** From and after the Effective Date, the Antenna Facilities and equipment permitted under the terms of the Agreement are limited to the Antenna Facilities and equipment described in Attachment B-6.

5. **Other Terms and Conditions Remain.** In the event of any inconsistencies between the Agreement and this Seventh Amendment, the terms of this Seventh Amendment shall control. This Seventh Amendment amends the Agreement in no other manner except as expressly set forth herein. The Parties acknowledge and agree that Exhibit A-3 of the Agreement has not been revised in any way by this Amendment. Except as expressly set forth in this Seventh Amendment, the Agreement is unmodified and remains in full force and effect. Each reference to the "Agreement" in the Agreement shall be deemed to refer to the Original License Agreement, as amended by the First Amendment, the Second Amendment, the Third Amendment, the Fourth Amendment, the Fifth Amendment, the Sixth Amendment, and this Seventh Amendment.

6. **Effective Date.** This Seventh Amendment shall not be effective unless and until it is executed by both the City and the Licensee. "**Effective Date**" as used herein means the later of the two dates this Seventh Amendment is executed by the City and Licensee.

7. **Signing Authority.** City and Licensee each warrant to the other that the person executing this Seventh Amendment on behalf of the warranting party has the full right, power

and authority to enter into, and execute, this Seventh Amendment on that party's behalf, and that no consent from any other person or entity is necessary as a condition precedent to the legal effect of this Seventh Amendment.

8. **Entire Agreement.** This Seventh Amendment, together with its attachments, sets forth the entire agreement of the parties with respect to the matters set forth herein. There are no oral agreements between the parties.

*[Signatures on following page]*

IN WITNESS WHEREOF, the City and the Licensee have executed this Seventh Amendment on the dates set forth below:

**CITY:**

**City of Mesquite,**  
a Texas home rule municipality

By:   
Printed Name: Cliff Ketrakoy  
Title: City Manager  
Date: 12-7-21

APPROVED AS TO FORM:

By:   
Printed Name: David L. Paschal  
Title: City Attorney  
Date: 11-22-21

**LICENSEE:**

**Cellco Partnership d/b/a Verizon Wireless**

By:   
Amanda Eastin

Verizon Sr. Manager – Central Texas  
Modifications, Small Cells, MLA &  
Community Outreach

Nov 18, 2021  
Date: \_\_\_\_\_

**ATTACHMENT A-2(C)**

**Site Plan**

(See attached)



5G L-SUB 6 PROJECT

SITE NAME: SAMUEL\_PARK  
 LOCATION CODE: 104821  
 STRUCTURE TYPE: 250'-0" SELF-SUPPORT TOWER



KGI WIRELESS, INC. TEXAS TRM NO. F-18692  
 805 LAS CINAS PKWY. SUITE 370  
 AUSTIN, TEXAS 78746  
 P. LICENSE NO. 08/31/2021



KGI WIRELESS, INC.  
 ENGINEERING  
 805 LAS CINAS PKWY  
 BUILDING THREE, SUITE 370  
 AUSTIN, TX 78746  
 512.345.9595

SITE NAME  
 SAMUEL\_PARK  
 LOCATION CODE  
 104821  
 SITE ADDRESS  
 1101 E MAIN ST.  
 MESQUITE, TX 75149

THESE DRAWINGS ARE THE PROPERTY OF VERIZON WIRELESS. THEY ARE INTENDED FOR THE EXCLUSIVE USE OF THIS PROJECT ONLY. ANY REUSE OR REPRODUCTION OF THESE DRAWINGS WITHOUT THE EXPRESS WRITTEN CONSENT OF VERIZON WIRELESS IS PROHIBITED.

ISSUED FOR:  
 PERMITTING REV 0 04/01/2021  
 PERMITTING REV 1 08/31/2021

NO	DESCRIPTION	BY	DATE
1	UPDATE DWG'S AND CABLES RA	RA	08/31/2021

SHEET TITLE:  
 TITLE SHEET

SHEET NUMBER:  
 T1

DRAWINGS INDEX

GENERAL SHEETS	REVISION
T1 TITLE SHEET	1
G01 GENERAL NOTES	0
C01 GENERAL PLANS	0
C1 SITE PLAN	1
C2 TOWER ELEVATION AND ANTENNA PLANS	1
C3 EQUIPMENT MOUNTING DETAILS	1
RF INFORMATION	0
RF1 ANTENNA SPECIFICATIONS	0
RF2 PROPOSED EQUIPMENT SPECS	0
RF3 PROPOSED EQUIPMENT SPECS	0
RF4 PROPOSED EQUIPMENT SPECS	0

ATTACHMENTS:  
 MOUNT MODIFICATION DESIGN BY T.E.S., DATED 08/26/2021

VICINITY MAP



TEAM SIGN-OFF

SITE ACQUISITION	DATE
CONSTRUCTION SUPERVISOR	DATE
RF ENGINEERING	DATE
EQUIPMENT	DATE
TELCO	DATE
CONSTRUCTION MANAGER	DATE

THE ABOVE PARTIES HEREBY APPROVE AND ACCEPT THESE DOCUMENTS AND ORDER CONTRACTOR TO PROCEED WITH THE CONSTRUCTION DESCRIBED HEREIN. CONTRACTOR SHALL BE RESPONSIBLE FOR THE LOCAL BUILDING DEPARTMENT AND MAY IMPOSE CHANGES OR MODIFICATIONS.

CONTACTS

APPLICANT:  
 VERIZON WIRELESS  
 5804 TRI COUNTY PARKWAY  
 SCHERTZ, TX 78154  
 CONTACT: DANNY DELEON  
 PHONE: 806.291.3853

SITE ACQUISITION:  
 KGI WIRELESS, INC.  
 BUILDING THREE, SUITE 370  
 805 LAS CINAS PKWY.  
 AUSTIN, TX 78746  
 PHONE: 512.345.9595

ENGINEER:  
 KGI WIRELESS, INC.  
 805 LAS CINAS PKWY.  
 AUSTIN, TX 78746  
 TYLER BOLLINGER, P.E.  
 PRINCIPAL ENGINEER  
 PHONE: 512.334.3296

UTILITY PROVIDER  
 AT SITE

PROJECT SUMMARY

LATITUDE: 32° 46' 07.42" N  
 LONGITUDE: 96° 35' 10.95" W  
 GROUND ELEVATION: ± 508.5' AMSL  
 SITE ADDRESS: 1101 E MAIN ST  
 MESQUITE, TX 75149  
 DALLAS COUNTY

CONSTRUCTION TYPE: UNMANNED TELECOMMUNICATIONS

JURISDICTION: CITY OF MESQUITE

SCOPE OF WORK

- 1) THIS WIRELESS COMMUNICATIONS FACILITY IS NOT INTENDED FOR HUMAN OCCUPANCY
- 2) THIS FACILITY DOES NOT REQUIRE POTABLE WATER AND WILL PRODUCE ANY SEWAGE.
- 3) THE SCOPE OF WORK FOR THIS PROJECT IS TO REMOVE EXISTING WIRELESS INSTALLATION OF MODIFYING THE EXISTING WIRELESS INSTALLATION:
  - A. REMOVE (6) RRHS (REMOTE RADIO HEADS)
  - B. REMOVE (10) COAX CABLES
  - C. REMOVE (2) HYBRID CABLES
  - D. INSTALL (3) ANTENNAS
  - E. INSTALL (6) RRHS
  - F. INSTALL (4) HYBRID DISTRIBUTION BOXES
  - G. INSTALL (2) HYBRID CABLES

APPLICABLE CODES & STANDARDS

- INTERNATIONAL BUILDING CODE, 2015 EDITION
- AS ADOPTED BY LOCAL JURISDICTION
- NATIONAL ELECTRICAL CODE, 2014 EDITION
- AS ADOPTED BY LOCAL JURISDICTION



Know what's below.  
 Call before you dig.

THESE DRAWINGS ARE FOR PERMITTING AND CONSTRUCTION PURPOSES

NOTE: DRAWING SCALES ARE FOR 11"X17" SHEETS UNLESS OTHERWISE NOTED.

**GENERAL NOTES**

1. THE CONTRACTOR SHALL SUPERVISE AND DIRECT ALL WORK USING HIS BEST SKILL AND ATTENTION. HE SHALL BE SOLELY RESPONSIBLE FOR ALL CONSTRUCTION MEANS, METHODS, TECHNIQUES, PROCEDURES AND SEQUENCES FOR COORDINATING ALL PORTIONS OF THE WORK UNDER CONTRACT.
2. THE CONTRACTOR SHALL VISIT THE JOB SITE TO REVIEW THE SCOPE OF WORK AND EXISTING JOB SITE CONDITIONS INCLUDING, BUT NOT LIMITED TO, MECHANICAL, ELECTRICAL SERVICE, AND OVERALL CONDITION.
3. THE CONTRACTOR SHALL VERIFY ALL EXISTING CONDITIONS AND DIMENSIONS PRIOR TO SUBMITTING HIS BID. ANY DISCREPANCIES, CONFLICTS OR OMISSIONS, ETC. SHALL BE REPORTED TO VERIZON BEFORE PROCEEDING WITH THE WORK.
4. THE CONTRACTOR SHALL PROTECT ALL AREAS FROM DAMAGE WHICH MAY OCCUR DURING CONSTRUCTION. ANY DAMAGE TO NEW AND EXISTING CONSTRUCTION, STRUCTURE, OR EQUIPMENT SHALL BE IMMEDIATELY REPAIRED OR REPLACED TO THE SATISFACTION OF THE TENANT OR BUILDING OWNER, OR OWNER'S REPRESENTATIVE AT THE EXPENSE OF THE CONTRACTOR.
5. THE CONTRACTOR SHALL BE RESPONSIBLE FOR, AND SHALL REPLACE OR REMEDY ANY FAULTY, IMPROPER, OR INFERIOR MATERIALS OR WORKMANSHIP OR ANY DAMAGE WHICH SHALL APPEAR WITHIN ONE YEAR AFTER THE COMPLETION AND ACCEPTANCE OF THE WORK UNDER THIS CONTRACT.
6. THE CONTRACTOR SHALL REMOVE ALL RUBBISH AND WASTE MATERIALS ON A REGULAR BASIS, AND SHALL EXERCISE STREET CONTROL OVER JOB CLEANING THROUGHOUT CONSTRUCTION, INCLUDING FINAL CLEAN-UP UPON COMPLETION OF WORK. ALL AREAS ARE TO BE LEFT IN A BROOM CLEAN CONDITION AT THE END OF EACH DAY.
7. THE CONTRACTOR SHALL SAFEGUARD THE OWNER'S PROPERTY DURING CONSTRUCTION AND SHALL REPLACE ANY DAMAGED PROPERTY OF THE OWNER TO ORIGINAL CONDITION OR BETTER.
8. IT SHALL BE THE RESPONSIBILITY OF THE CONTRACTOR TO LOCATE ALL EXISTING UTILITIES, INCLUDING BUT NOT LIMITED TO, WATER, GAS, AND CABLES. THE CONTRACTOR SHALL BEAR ALL EXPENSES FOR REPAIR OR REPLACEMENT OF UTILITIES OR OTHER PROPERTY DAMAGED IN CONNECTION WITH THE EXECUTION OF WORK.
9. THE CONTRACTOR SHALL BE RESPONSIBLE FOR THE COMPLETE SECURITY OF THE SITE WHILE THE JOB IS IN PROGRESS AND UNTIL THE JOB IS COMPLETED PER CHAPTER 44 OF THE U.S.C.
10. THE CONTRACTOR DURING CONSTRUCTION SHALL PROVIDE TEMPORARY WATER, POWER, AND TOILET FACILITIES AS REQUIRED BY THE CITY OR GOVERNING AGENCY.
11. ALL CONSTRUCTION WORK SHALL CONFORM TO THE U.S.C. AND ALL OTHER GOVERNING CODES, ALONG WITH THE GOVERNING RESTRICTIVE CODES.
12. THE CONTRACTOR AND ALL SUBCONTRACTORS SHALL COMPLY WITH ALL LOCAL CODE REGULATIONS AND STATE DEPARTMENT OF INDUSTRIAL REGULATIONS AND DIVISION OF INDUSTRIAL SAFETY (OSHA) REQUIREMENTS.
13. THE CONTRACTOR SHALL OBTAIN AND PAY FOR PERMITS, LICENSES, AND INSPECTIONS NECESSARY FOR PERFORMANCE OF THE WORK AND INCLUDE THOSE IN THE COST OF THE WORK TO THE OWNER.
14. FIGURED DIMENSIONS HAVE PRECEDENCE OVER DRAWINGS SCALE AND DETAIL DRAWINGS HAVE PRECEDENCE OVER SMALL SCALE DRAWINGS. OVERLAPPING DIMENSIONS SHALL BE INTERPRETED TO SHOW THE CONSTRUCTION UNTIL THE ACCURACY OF DRAWINGS DIMENSIONS HAS BEEN VERIFIED AGAINST ACTUAL FIELD DIMENSIONS.
15. CONTRACTOR SHALL NOTIFY THE ENGINEER OF ANY CONFLICTS OR DISCREPANCIES WITHIN THE CONTRACT DOCUMENTS WITH THE CONTRACT DOCUMENTS AND THE FIELD CONDITIONS PRIOR TO EXECUTING THE WORK IN QUESTION.
16. CONTRACTOR SHALL NOTIFY THE ENGINEER IF DETAILS ARE CONSIDERED UNSOUND, UNSAFE, NOT WEATHERPROOF, OR IN VIOLATION OF THE RESTRICTIVE CODES. WORK IS TO BE STOPPED IMMEDIATELY UNTIL THE ENGINEER HAS REVIEWED THE DETAILS AND BEEN ADVISED TO SHOW THE END RESULT OF THE DESIGN. MINOR MODIFICATIONS MAY BE REQUIRED TO SUIT JOB CONDITIONS, AND SHALL BE INCLUDED AS PART OF THE WORK.
17. EXISTING ELEVATIONS AND LOCATIONS TO BE JOINED SHALL BE VERIFIED BY THE CONTRACTOR BEFORE CONSTRUCTION. IF THE DETAILS FROM THOSE SHOWN ON THE PLANS, THE CONTRACTOR SHALL NOTIFY THE ENGINEER SO THAT MODIFICATIONS CAN BE MADE BEFORE PROCEEDING WITH THE WORK.
18. ALL SYMBOLS AND ABBREVIATIONS USED IN THE DRAWINGS ARE CONSIDERED CONSTRUCTION STANDARDS. IF THE CONTRACTOR HAS QUESTIONS REGARDING THEIR EXACT MEANING, THE ENGINEER SHALL BE NOTIFIED FOR CLARIFICATION BEFORE PROCEEDING WITH THE WORK.
19. CONTRACTOR SHALL PROVIDE ALL NECESSARY BLOCCING, BRACING, FRAMING, HANGERS OR OTHER SUPPORT FOR ALL OTHER ITEMS REQUIRING THE SAME.
20. CITY APPROVED PLANS SHALL BE KEPT IN A PLAN BOX AND SHALL NOT BE USED BY WORKMEN. ALL CONSTRUCTION SETS SHALL REFLECT THE SAME INFORMATION. THE CONTRACTOR SHALL ALSO MAINTAIN, IN GOOD CONDITION, ONE COMPLETE SET OF PLANS WITH ALL REVISIONS, ADDENDA AND OTHER CHANGE ORDERS ON THE PREMISE AT ALL TIMES. THESE ARE TO BE UNDER THE CARE OF THE JOB SUPERINTENDENT.
21. ALL CONDUITS AND CABLE RUNS ARE DRAWN DIAGRAMMATICALLY. CONTRACTOR SHALL RUN CONDUITS AND CABLES IN COMPLIANCE WITH THE NATIONAL ELECTRIC CODE ALONG THE BEST POSSIBLE ROUTE. THE INSTALLATION OF CONDUITS AND CABLES WILL FOLLOW THE DRAWINGS AS TO SUPPORT AND EQUIPMENT.

22. KGI'S SCOPE OF WORK DOES NOT INCLUDE A STRUCTURAL EVALUATION OF THE SITE, THIS APPURTENANCE, EQUIPMENT, AND TRANSMISSION CABLES SHOWN ON THESE DRAWINGS ARE SCHEMATIC AND FOR REFERENCE ONLY. A STRUCTURAL EVALUATION OF THE SITE STRUCTURE, ANTENNA MOUNTINGS AND HARDWARE SHOULD BE PERFORMED AND RECOMMENDATIONS IMPLEMENTED PRIOR TO THE INSTALLATION OF THIS SCOPE OF WORK. THENCE, INFORMATION INDICATED IN THE STRUCTURAL ANALYSIS REGARDING FINAL APPURTENANCE/EQUIPMENT/CABLE ARRANGEMENT AND DETAILS SUPERCEDES THESE DRAWINGS.

**EQUIPMENT NOTES**

1. ALL RADIO EQUIPMENT PLACEMENT AND INSTALLATION IS BY AN EQUIPMENT SUPPLIER WHO IS RESPONSIBLE FOR COORDINATING HIS WORK WITH THE WORK OF OTHERS AS IT RELATES TO THE RADIO EQUIPMENT.
1. PROVIDE A PORTABLE FIRE EXTINGUISHER WITH A RATING OF NOT LESS THAN 2-A OF 2-410BC WITHIN 75 FEET OF TRAVEL DISTANCE TO ALL PORTIONS OF THE BUILD OUT AREA DURING CONSTRUCTION.
2. ANY ALTERATION TO EXISTING FIRE PROTECTION FACILITIES WILL REQUIRE CLEARANCE AND PERMITS FROM THE GOVERNING FIRE DEPARTMENT AND OTHER AGENCIES BY A LICENSED FIRE PROTECTION CONTRACTOR.

**TENANT IMPROVEMENT NOTES**

**ANTENNA NOTES**

1. ANTENNA CONTRACTOR SHALL ENSURE THAT ALL ANTENNA MOUNTING PIPES ARE PLUMB.
2. COAXIAL FEEDER AND FIBER LENGTHS INDICATED ARE APPROXIMATE.
3. ANTENNA COAXIAL FEEDERS AND ANTENNA JUMPERS SHALL BE COLOR CODED PER VERIZON REQUIREMENTS.
4. MULTI-PORT ANTENNAS: TERMINATE UNUSED ANTENNA PORTS WITH CONNECTOR CAP AND WEATHERPROOF THROUGHOUT. JUMPERS FROM TMA'S MUST TERMINATE TO OPPOSITE POLARIZATIONS IN EACH SECTOR.
5. CONTRACTOR MUST FOLLOW ALL MANUFACTURER'S RECOMMENDATIONS REGARDING THE INSTALLATION OF COAXIAL CABLES, CONNECTORS, AND ANTENNAS.
6. CONTRACTOR SHALL RECORD THE SERIAL#, SECTOR, AND POSITION OF EACH ANTENNA AND ACTUATOR INSTALLED AT THE ANTENNAS AND FURNISH THE INFORMATION TO VERIZON.
7. ANTENNA CONTRACTOR SHALL PERFORM A "TAPE DROP" MEASUREMENT TO CONFIRM/VALIDATE ANTENNA CENTERLINE (ACS) HEIGHT. CONTRACTOR SHALL SUBMIT A COMPLETED HEIGHT VERIFICATION FORM TO THE CONSTRUCTION MANAGER.
8. ALL FIBER RUNS TO BE CONTAINED IN A SINGLE HYBRID DC POWER/FIBER CABLE FROM UPPER OVP TO LOWER OVP (COLOR CODE COAX JUMPERS ONLY).
9. WEATHERPROOF UNUSED TMA AND RADIO UNIT PORTS.
10. ALL ANTENNA ADMITTITS TO BE FROM TRUE NORTH.



KGI WIRELESS, INC. TEXAS PERM. NO. P-108927  
 1101 E. MAIN ST.  
 MESQUITE, TEXAS 75149  
 EXPIRES PERMANENT 06/30/2022



KGI WIRELESS, INC.  
 ENGINEERING  
 805 LAS CIMAS PKWY  
 BUILDING THREE, SUITE 370  
 AUSTIN, TX 78748  
 512.345.9595

SITE NAME  
 SAMUEL PARK  
 LOCATION CODE  
 104821  
 SITE ADDRESS:  
 1101 E. MAIN ST.  
 MESQUITE, TX 75149

THESE DRAWINGS ARE THE PROPERTY OF KGI WIRELESS, INC. AND ARE NOT TO BE REPRODUCED, COPIED, OR TRANSMITTED IN ANY FORM OR BY ANY MEANS, WITHOUT THE EXPRESS WRITTEN CONSENT OF KGI WIRELESS, INC. KGI WIRELESS IS PROHIBITED FROM REPRODUCING THESE DRAWINGS.

ISSUED FOR:  
 PERMITTING REV 0  
 PERMITTING REV 1  
 DATE  
 04/01/2021  
 06/31/2021

NO	DESCRIPTION	BY	DATE

REVISION

SHEET TITLE:  
 GENERAL NOTES

SHEET NUMBER:  
 GN1



KG WIRELESS, INC. TEXAS PERM NO. F-10992Z  
 PERM EXPIRES 08/31/2021  
 FL LICENSE NUMBER: 06700262



KGI WIRELESS, INC.  
 ENGINEERING  
 805 LAS CIMAS PKWY  
 BUILDING THREE, SUITE 370  
 AUSTIN, TX 78746  
 512.345.9595

SITE NAME  
 SAMUEL PARK  
 LOCATION CODE  
 104821  
 SITE ADDRESS:  
 1101 E. MAIN ST.  
 MESSOUIE, TX 75149

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ISSUED FOR:  
 PERMITTING REV 0  
 DATE 04/01/2021  
 PERMITTING REV 1  
 DATE 08/31/2021

NO	DESCRIPTION	BY	DATE
1	UPDATE OVP'S AND CABLES RA		08/31/2021



REVISION

SHEET TITLE:

SITE PLAN

SHEET NUMBER:

C1

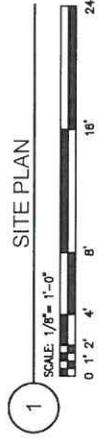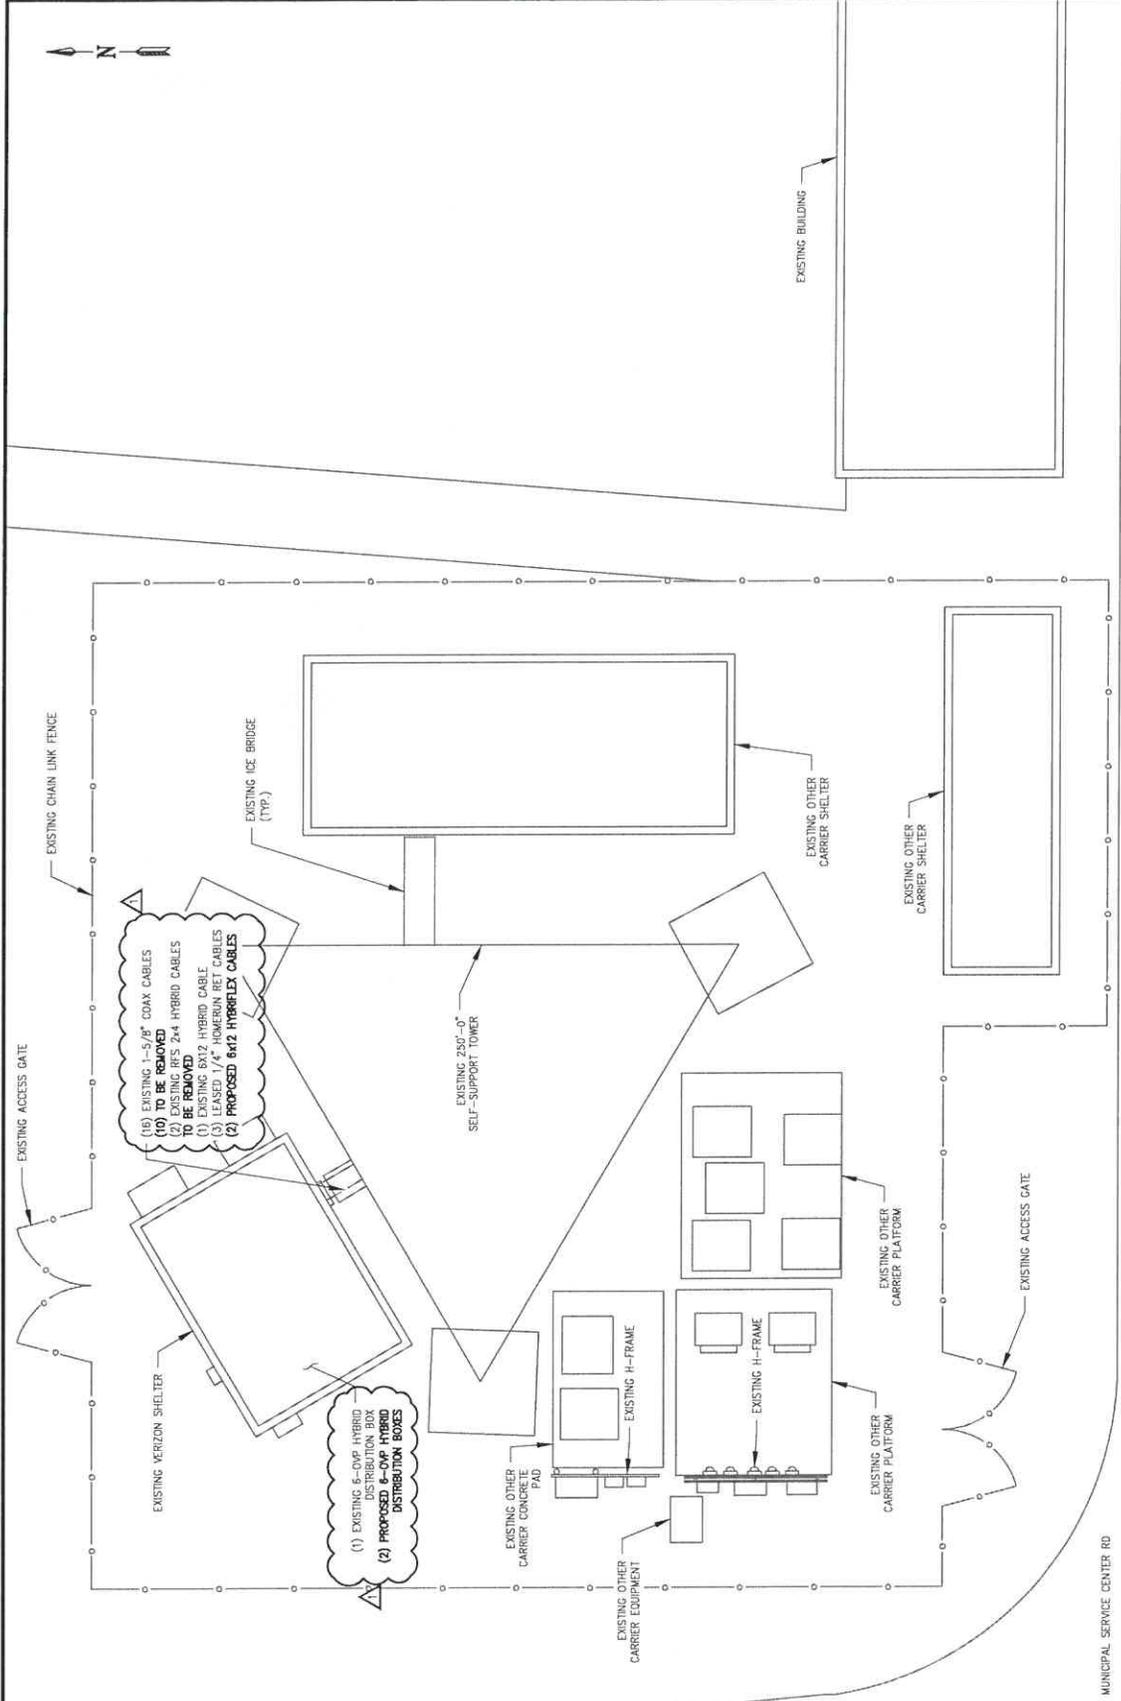

SCALE: 1/8" = 1'-0"


1

THIS SITE PLAN WAS DRAWN WITHOUT THE BENEFIT OF A CIVIL SURVEY; THEREFORE, THE CONTRACTOR SHALL VERIFY ALL EXISTING CONDITIONS, QUANTITIES AND DIMENSIONS BEFORE STARTING ANY WORK. NOTIFY THE CONSTRUCTION MANAGER OF ANY DISCREPANCIES OR INCONSISTENCIES BEFORE PROCEEDING WITH THE WORK.

MUNICIPAL SERVICE CENTER RD




**NOTE:**  
 1. CONTRACTOR SHALL VERIFY THE MOUNT MODEL AND EXISTING CONFIGURATIONS, CONNECTIONS AND STRUCTURE WITH THIS DRAWING AND STOP ANY WORK AND NOTIFY THE STRUCTURAL ENGINEER IN CASE OF ANY DISCREPANCIES.  
 2. ALL EXISTING PRE-MOUNTS, BRACKETS, AND CONNECTIONS SHALL BE INSPECTED FOR ANY STRUCTURAL DEFICIENCIES. (I.E. ANY LOOSE, BENT AND DAMAGED MEMBERS) AND ANY DAMAGED MEMBERS SHOULD BE REPLACED WITH EQUAL MEMBER AND/OR PART OR BETTER AND ANY LOOSE BOLTED CONNECTIONS SHOULD BE TIGHTENED AS REQUIRED.

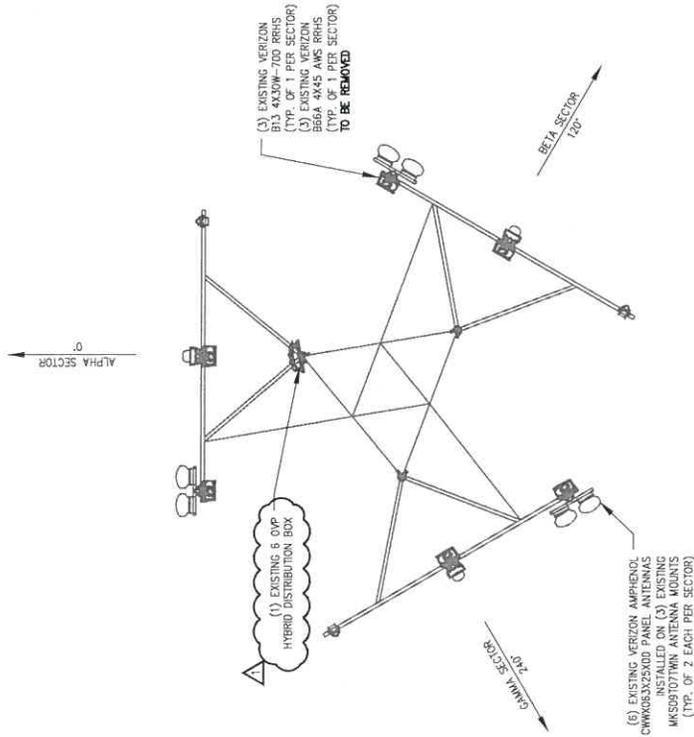

1 EXISTING ANTENNA PLAN  
 SCALE: N.T.S.

**NOTE:**  
 1. CONTRACTOR SHALL VERIFY THE MOUNT MODEL AND EXISTING CONFIGURATIONS, CONNECTIONS AND STRUCTURE WITH THE ATTACHED SPECIFICATIONS AND STOP ANY WORK AND NOTIFY THE STRUCTURAL ENGINEER IN CASE OF ANY DISCREPANCIES.  
**MODIFICATION NOTE:**  
 MOUNT REQUIRES MODIFICATION BEFORE ANY NEW EQUIPMENT IS INSTALLED. REFERENCE T.E.S. MOUNT MODIFICATION DRAWINGS DATED 03/23/2021.

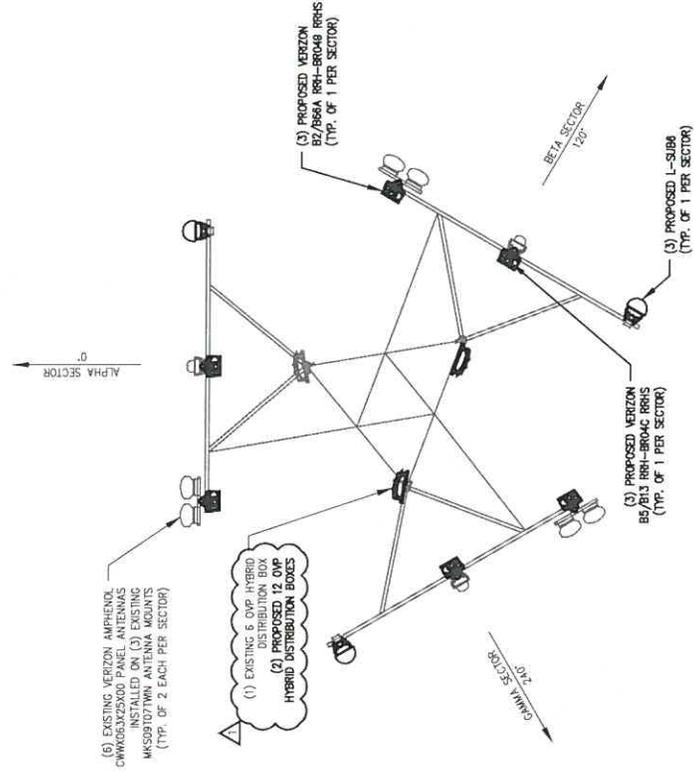

2 PROPOSED ANTENNA PLAN  
 SCALE: N.T.S.



KGI WIRELESS, INC. TEXAS PERM NO. F-19692  
 PER REGISTRATION RENEWAL 12/31/2021  
 PE LICENSE RENEWAL 09/30/2022



KGI WIRELESS, INC.  
 ENGINEERING  
 805 LAS CUMAS PIQWAY  
 BUILDING THREE, SUITE 370  
 AUSTIN, TX 78746  
 512.345.9595

SITE NAME  
 SAMUEL PARK  
 LOCATION CODE  
 104821

SITE ADDRESS:  
 100 MAIN STREET  
 MESQUITE, TX 75149

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ISSUED FOR:  
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 PERMITTING REV 1 08/31/2021

NO	DESCRIPTION	BY	DATE
1	UPDATE OVP'S AND CABLES RA		08/31/2021

SHEET TITLE:  
 ANTENNA PLANS  
 SHEET NUMBER:  
 C3

**Amphenol**  
ANTENNA SOLUTIONS

**696-960 MHz**

**CX063X25x00**

X-Pol | Single Band VET Panel | 65° | 16.8 dBi

Ordering Options	
Manual Electrical Tilt	CX063X25V100
Remote Electrical Tilt (AESG v1.1)	CX063X25R00
Remote Electrical Tilt (AESG v2.0 / 3GPP)	CX063X25C00

Electrical Characteristics	
Frequency bands (MHz)	696-960 MHz
Polarization	696-966
Horizontal beamwidth	14.5°
Vertical beamwidth	7.4°
Gain	16.3 dBi
Electrical downtilt	0-10°
Impedance	50Ω
VSWR	< 1.5:1
Upper sideband suppression	< -18 dB typical
Front-to-back ratio	> 25 dB
In-band isolation	> 25 dB
Input power	2+ 500 W
IM3 (2x20W carriers)	< -153 dBc
Lightning protection	Direct Ground
Operating temperature	-40° to +140° C (-40° to +140° F)
Connectors	2 Ports / 7/16 DIN / Female / Bottom

Mechanical Characteristics	
Dimensions Length x Width x Depth	2588 x 305 x 180 mm
Weight without mounting brackets	15.9 kg
Weight without mounting brackets (RET)	16.2 kg
Survival wind speed	241 km/hr
Wind load at 100 km/hr or 100 mph	Front: 930 N, Side: 550 N
Remote Electrical Tilt (RET) Control	Front: 209, Side: 124 lbf

The remote control of the electrical tilt is achieved by a module (MOCU) which is inserted at the bottom of the antenna. One single module controls individually the tilt of each band (no need of daisy chain cables between the bands). This module does not add any additional length at the bottom of the antenna. For RET control, the visible and the antenna still has manual tilt control (manual overalls).

MOCU-A009 for AESG v1.1 protocol (one unit included in CX063X25S000)  
MOCU-C000 for 3GPP/AESG v2.0 protocol (one unit included in CX063X25S001)

**RET Module Part Number**  
(one per antenna)

**Important Installation Instructions**  
In order to operate RET control, the transparent cap covering the instructions must be engaged and locked. Do not cut the cap from the antenna.

Mounting Options	
3-Point Mounting Bracket Kit	MKS3P02Z
3-Point Mounting & Downrail Bracket Kit	MKS3P02Z
Ti-Stacker UNICELL Options	UNK-20-4

For use inside UNICELL modules.

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**Amphenol**  
ANTENNA SOLUTIONS

**1710-2170 MHz**

**W85-19-x28**

Single Band | Panel Antenna | X-Pol | 85° | 18.3 dBi | Variable Tilt

- Single band, X-Pol, variable tilt, panel antenna
- MET and RET versions, AISG v1.1 or 3GPP/AISG v2.0
- External RET unit

Ordering Options	
Manual Electrical Tilt	W85-19-V128
Remote Electrical Tilt (AESG v1.1)	W85-19-R28
Remote Electrical Tilt (3GPP/AISG v2.0)	W85-19-R28G

Electrical Characteristics	
Frequency Bands	1710-1980 MHz
Polarization	±45°
Horizontal Beamwidth	85°
Vertical Beamwidth	5.3°
Gain	17.5 dBi
Electrical Downtilt	2.8° Variable Electrical Tilt
Impedance	50Ω
VSWR	< 1.4:1
Upper Sideband Suppression	< -18 dB
Front-to-Back Ratio	> 25 dB
Intra-Port Isolation	> 28 dB
IM3 (2x20W Carriers)	< -153 dBc
Input Power	2 x 200W
Total Number of Connectors / Type / Location	2 Ports / 7/16-DIN Female / Bottom
Operating Temperature	-40° to +60° C (-40° to +140° F)

Mechanical Characteristics	
Dimensions (L x W x D)	1935 x 170 x 100 mm
Antenna Weight without Mounting Brackets	11.0 kg
Dimensions (L x W x D)	2105 x 170 x 100 mm
Antenna Weight without Mounting Brackets	11.7 kg
Survival Wind Speed	241 km/hr
Wind Load at 161 km/hr (100 mph)	Front: 402 N Side: 234 N

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1 of 4

**1710-2170 MHz**



Ordering Options	
Manual Electrical Tilt	W85-19-V128
Remote Electrical Tilt (AESG v1.1)	W85-19-R28
Remote Electrical Tilt (3GPP/AISG v2.0)	W85-19-R28G

Electrical Characteristics	
Frequency Bands	1710-1980 MHz
Polarization	±45°
Horizontal Beamwidth	85°
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1 of 4

**1710-2170 MHz**



Ordering Options	
Manual Electrical Tilt	W85-19-V128
Remote Electrical Tilt (AESG v1.1)	W85-19-R28
Remote Electrical Tilt (3GPP/AISG v2.0)	W85-19-R28G

Electrical Characteristics	
Frequency Bands	1710-1980 MHz
Polarization	±45°
Horizontal Beamwidth	85°
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**1710-2170 MHz**



Ordering Options	
Manual Electrical Tilt	W85-19-V128
Remote Electrical Tilt (AESG v1.1)	W85-19-R28
Remote Electrical Tilt (3GPP/AISG v2.0)	W85-19-R28G

Electrical Characteristics	
Frequency Bands	1710-1980 MHz
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**1710-2170 MHz**



Ordering Options	
Manual Electrical Tilt	W85-19-V128
Remote Electrical Tilt (AESG v1.1)	W85-19-R28
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**1710-2170 MHz**



Ordering Options	
Manual Electrical Tilt	W85-19-V128
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**1710-2170 MHz**



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**1710-2170 MHz**



Ordering Options	
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Mechanical Characteristics	
----------------------------	--

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KGI WIRELESS, INC.  
ENGINEERING  
805 LAS CIMAS PKWY  
BUILDING THREE, SUITE 370  
AUSTIN, TX 78746  
512.345.9595

SITE NAME: SAMUEL PARK  
LOCATION CODE: 104821  
SITE ADDRESS: 110 E MAIN ST, MESQUITE, TX 75149


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ISSUED FOR: DATE  
PERMITTING REV 0 04/01/2021  
PERMITTING REV 1 08/31/2021

NO	DESCRIPTION	BY	DATE

SHEET TITLE: PROPOSED EQUIPMENT SPECS  
SHEET NUMBER: RF2

Unit: in. (mm)

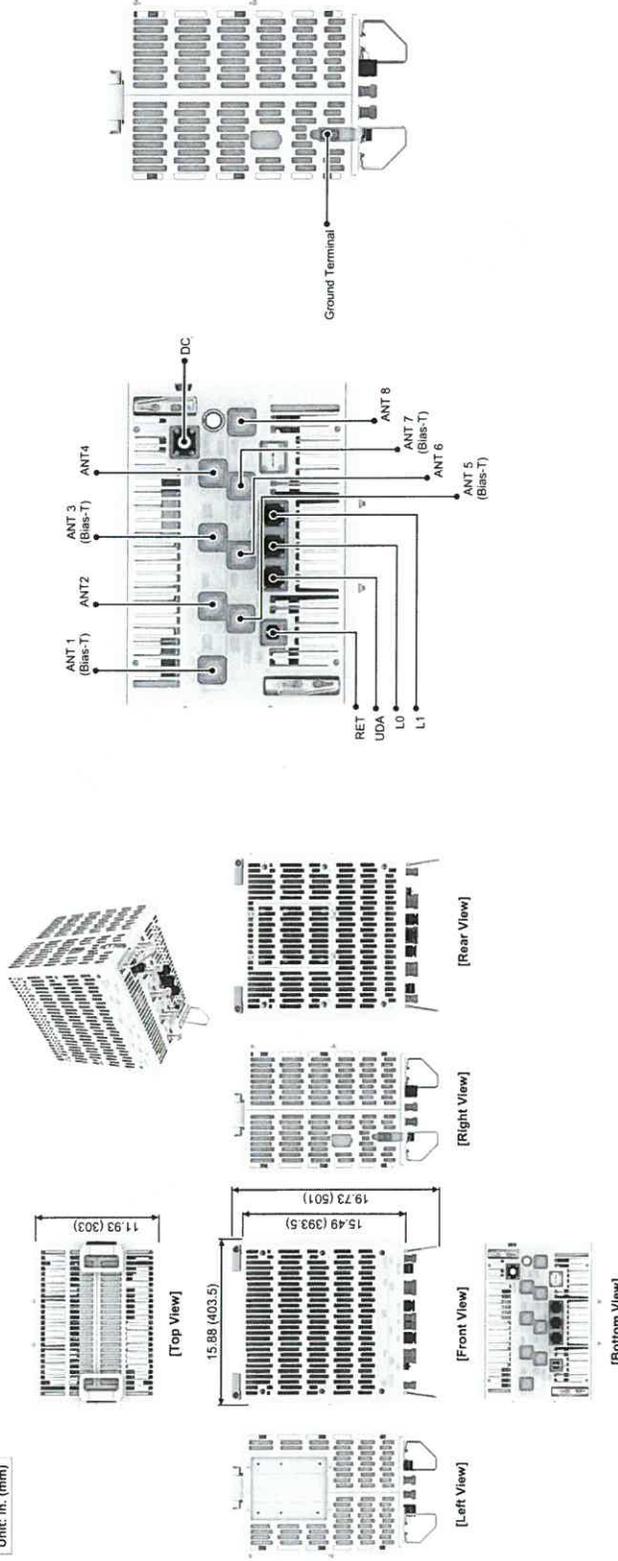

1 PROPOSED EQUIPMENT SPECS

SCALE: N.T.S.

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KGI WIRELESS, INC.  
ENGINEERING  
805 LAS CIMAS PKWY  
BUILDING THREE, SUITE 370  
AUSTIN, TX 78748  
512.345.9595

SITE NAME  
SAMUEL PARK  
LOCATION CODE  
104821  
SITE ADDRESS:  
1100 E. ARROYO  
MESQUITE, TX 75149






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PERMITTING REV 1 08/31/2021

REVISION	
NO	DESCRIPTION BY DATE

SHEET TITLE:  
PROPOSED EQUIPMENT SPECS  
SHEET NUMBER:  
RF3

Unit: in. (mm)

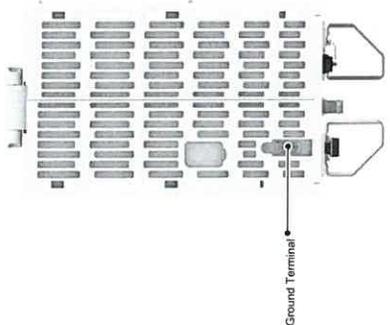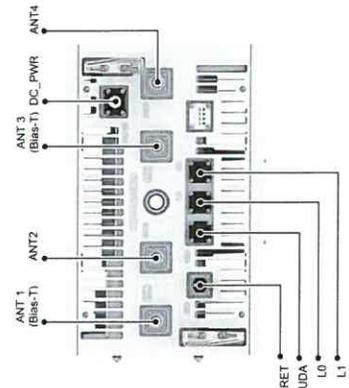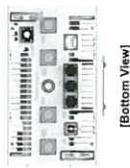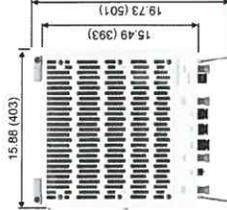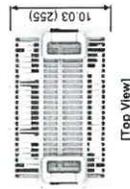


1 PROPOSED EQUIPMENT SPECS  
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Overview

**SAMSUNG**

The following figures depict the physical views of the MT6407-77A.

Figure 1. Appearance

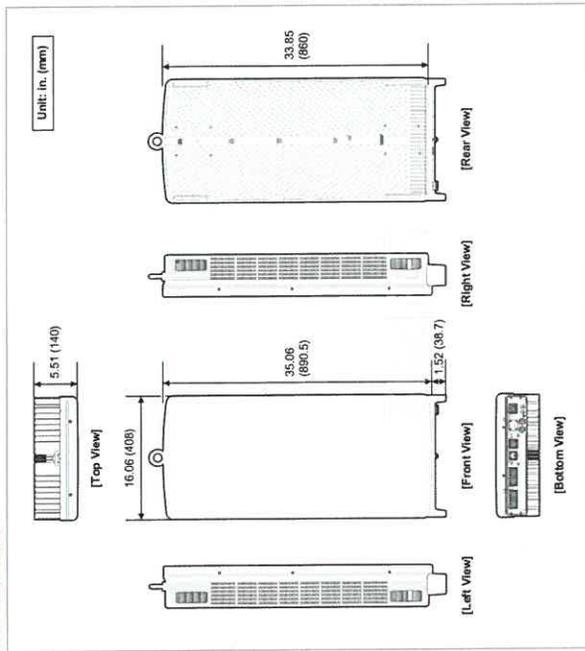

102 MT6407-77A Product Specification v3.0  
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Specifications

**SAMSUNG**

**Specifications**

The following table displays the main specifications of the MT6407-77A.

Table 2. Specifications

Item	Description
Air Technology	NR
Frequency	3700-3980 MHz
IBW	280 MHz
OBW	200 MHz
Carrier Bandwidth	20/40/60/80/100 MHz
Number of Carriers	2 carriers (Contiguous, Non-Contiguous) • NR 1C: 20/40/60/80/100M • NR 1CC+1CC: 20/40/60/80/100M + 20/40/60/80/100M
Layer	• DL: 16 Layers • UL: 16 RX (8 Layers)
RF Chain	64T64R
Antenna Configuration	4 Y16H with 192 AE
EIRP	78.5 dBm (53 dBm + 25.5 dBi)
Conductive Power	200 W
Spectrum Analyzer	TX/RX support
Modulation	DL: 256QAM support, (DL 1024QAM with 1-2 dB power back-off)
Function Split	DU/LU Option 7-2x
Fronthaul Interface	CPRI, eCPRI
Optic Interface	4 ports (25 Gbps x 4), SFP28, single mode, Bi-di (Option: Duplex), 15 km
External Alarm	4 RX
Input Power	-48 VDC (-38 to -57 VDC)
Power Consumption[Note]	• 1.395 W @ 100 % RF load, room temperature • 1.428 W @ 100 % RF load, all temperature • 1.003 W @ 40% RF load, room temperature
Size (WHD)	408 x 600.5 x 140 mm (16.06 x 35.06 x 5.51 inch)
Volume	50.9 L
Weight	37 kg or less
Operating Temperature	-40-55 °C (w/o solar load)
Operating Humidity	5-100 % RH RH, non-condensing, not to exceed 30 g/m <sup>3</sup> absolute humidity.
Waterproof/Dustproof	IEC 60529 IP65
Earthquake	Telcordia GR-63-Core, Zone4
Cooling	Natural convection
Mounting Options	Pole, wall

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ENGINEERING  
805 LAS CIMAS PKWY  
BUILDING THREE, SUITE 370  
AUSTIN, TX 78748  
512.345.9955

SITE NAME: SAMUEL\_PARK  
LOCATION CODE: 104821  
SITE ADDRESS: 1101 E MAIN ST, MESSOUITE, TX 75149

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PERMITTING REV 1	06/31/2021

REVISION	
NO	DESCRIPTION

SHEET TITLE: PROPOSED EQUIPMENT SPECS  
SHEET NUMBER: RF4

**PROPOSED L-SUB 6 EQUIPMENT SPECS**

SCALE: N.T.S.

1

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# MOUNT MODIFICATION DRAWINGS

PROPOSED CARRIER: VERIZON

CARRIER SITE NUMBER: 104821-VZW  
 CARRIER SITE NAME: SAMUEL\_PARK

COORDINATES (LATITUDE: 32.768730°, LONGITUDE: -96.586380°)

FUZE ID # 16229054



**Tower Engineering Solutions**  
 1320 GREENWAY BLVD, SUITE 600  
 IRVING, TX 75039  
 PH: (972) 483-0067



TSJ JOB NO: 10096019  
 CUSTOMER SITE NO: 104821-VZW  
 CUSTOMER SITE NAME: SAMUEL\_PARK  
 1101 E MAIN ST  
 MESQUITE, TX 75149  
 TOWER ENGINEERING SOLUTIONS, LLC  
 TEXAS REGISTRATION NUMBER: 113009  
 Exp: 09/30/2021



MUSTAPHA ASSI  
 101771  
 LICENSED PROFESSIONAL ENGINEER  
 STATE OF TEXAS  
 08/26/2021

DRAWN BY: MG | CHECKED BY: PK/SK  
 REV: \_\_\_\_\_ BY: \_\_\_\_\_ DATE: \_\_\_\_\_  
 Δ: FIRST ISSUE: MG, 08/26/21  
 Δ: \_\_\_\_\_  
 Δ: \_\_\_\_\_  
 Δ: \_\_\_\_\_  
 SHEET FILE: \_\_\_\_\_

TITLE SHEET

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SHEET	SHEET TITLE	REV
ST-1	TITLE SHEET	0
SR0M	BILL OF MATERIALS	0
SGM-1	GENERAL NOTES	0
SCF-1	CLIMBING FACILITY DETAILS	0
SS-1	ANTENNA MOUNT MODIFICATION DETAILS	0
SS-2	STANDARD DETAILS	0
SS-3	STANDARD DETAILS	0
SS-4	STANDARD DETAILS	0
SS-5	STANDARD DETAILS	0
SS-6	MOUNT PHOTOS	0
-	SPECIFICATION SHEETS	0

Contractor PMI Requirements	
PMI Accessed At	<a href="https://pmi.vzwsmart.com">https://pmi.vzwsmart.com</a>
Smart Tool Vendor Number	10096019
Post MOD Analysis Report Project Number	10096019
VzW Location Code (PSLC)	104821
Report Dated	8/23/2021
*** PMI and Requirements embedded in Mount Analysis Report	
<b>VZW APPROVED SMART KIT VENDORS</b>	
Refer to Mount Modification Drawings Page for VzW SMART KIT Approved Vendors	

BILL OF MATERIALS

QUANTITY COUNTED	QUANTITY PROVIDED	PART NUMBER	DESCRIPTIONS	SHEET LIST	PIECE WEIGHT (LBS)	WEIGHT (LB)	NOTES
4	4	VZWSMART-MSK7	ANGLE TO ANGLE CROSSOVER MATERIAL & HARDWARE	SS-1, VZWSMART-MSK7	7.0	28.0	Galvanized
<b>FOLLOWING ITEMS ARE "CUSTOM" PARTS</b>							
3	3	PV-MD-CS-18R	PERFECT VISION MICROWAVE STRUT SUPPORT FACE MOUNT KIT	SS-1, SS-2	120.00	378.0	GALVANIZED
2	2	P40-238M072	PIPE 2 SCH40 (2.375" OD X 0.154" THK) X 6'-0" LONG	SS-1, SS-5	22.61	45.2	GALVANIZED (FINAL CUT LENGTH TO BE DETERMINED IN FIELD)
3	3	P40-238M174	PIPE 2 SCH40 (2.375" OD X 0.154" THK) X 14'-6" LONG	SS-3	0.00	0.0	GALVANIZED (FINAL CUT LENGTH TO BE DETERMINED IN FIELD)
6	6	PL375-4511	PL 3/8" X 4 1/2" X 11" A36	SS-3	0.00	0.0	GALVANIZED
6	6	V-CLAMP	PL 1/2" X 4 1/4" X 8 5/8" A36	SS-3	0.00	0.0	GALVANIZED
6	6	BP2-875	PL 1/4" X 2" X 8 3/4" A36 BENT PLATE	SS-3	0.00	0.0	GALVANIZED
24	26	---	BOLT 5/8" X 6" FUL. THREAD SAE GR 5	SS-3	0.00	0.0	(1) HHN & LKW-EA GALVANIZED
6	7	---	BOLT 5/8" X 4 1/4" A325	SS-3	0.00	0.0	(1) HHN & LKW-EA GALVANIZED
6	7	---	BOLT 5/8" X 2" A325	SS-3	0.00	0.0	(1) HHN & LKW-EA GALVANIZED
				<b>TOTAL WEIGHT (LBS) =</b>	<b>451.2</b>		

V2W Mount Modification Kits - Approved Vendors

**Contact:** Perfect Vision  
**Phone Number:** Wireless Sales 844.887.6723  
**Website:** [wirelessales@perfect-vision.com](mailto:wirelessales@perfect-vision.com)  
[www.perfect-vision.com](http://www.perfect-vision.com)

**Contact:** Kent Ramey  
**Phone Number:** (O) 706.335.7045  
**Website:** [kent@metrositelc.com](mailto:kent@metrositelc.com)  
 (M) 706.982.9788  
[metrositefabricators.com](http://metrositefabricators.com)

**Contact:** Sabre Industries Inc  
**Phone Number:** Angie Welch 866.428.6937  
**Website:** [awelch@sabreindustries.com](mailto:awelch@sabreindustries.com)  
[www.sabresitesolutions.com](http://www.sabresitesolutions.com)

**Contact:** Paula Boswell  
**Phone Number:** 972.236.9843  
**Website:** [paula.boswell@salimont.com](mailto:paula.boswell@salimont.com)  
[www.charrn1.com](http://www.charrn1.com)

**Contact:** Salvador Anguilano  
**Phone Number:** 817.304.7492  
**Website:** [Salvador.Anguilano@commscope.com](mailto:Salvador.Anguilano@commscope.com)  
[www.commscope.com](http://www.commscope.com)

**Contact:** Sabre Industries Inc  
**Phone Number:** Angie Welch 866.428.6937  
**Website:** [awelch@sabreindustries.com](mailto:awelch@sabreindustries.com)  
[www.sabresitesolutions.com](http://www.sabresitesolutions.com)



**IES**  
 Tower Engineering Solutions  
 1320 GREENWAY DRIVE, SUITE 600  
 HOUSTON, TX 75038  
 PH: (972) 483-0607



IES JOB NO:  
10096019  
 CUSTOMER SITE NO:  
104821-VZW  
 CUSTOMER SITE NAME:  
SAMUEL\_PARK  
 1101 E MAIN ST  
 MESQUITE, TX 75149  
 TOWER ENGINEERING SOLUTIONS, LLC  
 1320 GREENWAY DRIVE, SUITE 600  
 HOUSTON, TX 75038  
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**GENERAL NOTES**

- ALL WORK SHALL COMPLY WITH THE ANSI/TIA-222-H, ANSI/ASSP A10.48, AND ANY OTHER GOVERNING BUILDING CODES AND OSHA SAFETY REGULATIONS.
- ALL WORK INDICATED ON THE DRAWINGS SHALL BE PERFORMED BY QUALIFIED CONTRACTORS EXPERIENCED IN TELECOMMUNICATIONS TOWER, POLE AND FOUNDATION CONSTRUCTION.
- THE CONTRACTOR SHALL BE RESPONSIBLE FOR THE DESIGN AND FABRICATION OF ALL MISCELLANEOUS PARTS (SUCH AS SHIMS), TEMPORARY SUPPORTS, AND CHAINING, ETC. PER ANSI/ASSP A10.48, TO COMPLETE THE ASSEMBLY AS SHOWN IN THE DRAWINGS. CONTRACTOR SHALL PROCEED WITH THE INSTALLATION WORK CAREFULLY SO THE WORK WILL NOT DAMAGE ANY EXISTING CABLE, EQUIPMENT OR THE STRUCTURE.
- THE USE OF GAS TORCH OR WELDER, ARE NOT ALLOWED ON ANY TOWER STRUCTURE WITHOUT THE CONSENT OF THE TOWER OWNER.
- GENERALLY THE CONTRACTOR IS RESPONSIBLE TO CONDUCT AN ON-SITE VISIT SURVEY OF THE JOB SITE AFTER AWARD, AND REPORT ANY ISSUES WITH THE SITE TO ITS BEFORE PROCEEDING CONSTRUCTION.
- TEMPORARILY RELOCATE ANY EXISTING COAX ATTACHED TO THE LEGS AND/OR ANY OTHER MEMBERS WHERE OBSTRUCTION WITH THE PROPOSED MODIFICATION MAY OCCUR.
- IT IS THE RESPONSIBILITY OF THE GC TO VERIFY THAT THERE IS NO INTERFERENCES (WITH SAFETY CLIMB BRACKETS, TRANSMISSION LINES, ETC.) PRIOR TO MOBILIZATION AND INSTALLATION OF THESE MODIFICATIONS.
- PLEASE NOTIFY TES IMMEDIATELY IF ANY INSTALLATION ISSUES OCCUR RELATED TO THIS DRAWING @ 972-483-0607 OR EMAIL-[TESORDER@TESTOWER.US](mailto:TESORDER@TESTOWER.US)

**FABRICATION**

- ALL STEEL SHALL MEET OR EXCEED THE MINIMUM STRENGTH AS SPECIFIED IN THE DRAWINGS. IF YIELD STRENGTH WAS NOT NOTED IN THE DRAWINGS, CONTRACTORS SHALL CONTACT TES FOR DIRECTION.
- ALL FIELD CUT EDGES SHALL BE GROUND SMOOTH, ALL FIELD CUT AND DRILLED SURFACES SHALL BE REPAIRED WITH A MINIMUM OF TWO COATS OF ZINGA COLD GALVANIZING COMPOUND PER ASTM A780 AND MANUFACTURER'S RECOMMENDATIONS.

**WELDING**


- ALL WELDING SHALL BE PERFORMED BY AWS CERTIFIED WELDERS AND IN ACCORDANCE WITH THE LATEST EDITION OF THE AWS WELDING CODE D1.1. ALL ELECTRODES TO BE LOW HYDROGEN, MATCHING FILLER METAL, PER AWS D1.1. UNO. (E70XX) UNLESS NOTED OTHERWISE).
- PRIOR TO FIELD WELDING GALVANIZED MATERIAL, CONTRACTOR SHALL GRIND OFF GALVANIZING APPROX. 0.5" BEYOND THE PROPOSED FIELD WELD SURFACES.
- ALL WELDS SHALL BE INSPECTED VISUALLY. A MINIMUM OF 25% OF WELDS SHALL BE INSPECTED WITH DYE PENETRANT OR MAGNETIC PARTICLE TO MEET THE ACCEPTANCE CRITERIA OF AWS D1.1. 100% OF WELDS SHALL BE INSPECTED IF DEFECTS ARE FOUND.
- WELD INSPECTIONS SHALL BE PERFORMED BY AN AWS CERTIFIED WELD INSPECTOR.
- AFTER INSPECTION, ALL FIELD WELDED SURFACES SHALL BE REPAIRED WITH A MINIMUM OF TWO COATS OF ZINGA COLD GALVANIZING COMPOUND PER ASTM A780 AND MANUFACTURER'S RECOMMENDATIONS.

**BOLTED ASSEMBLIES AND TIGHTENING OF CONNECTIONS**

- ALL HIGH STRENGTH BOLTS SHALL CONFORM TO THE PROVISIONS OF THE SPECIFICATIONS FOR STRUCTURAL JOINTS USING A325 OR A490 BOLTS AS APPROVED BY THE RCSC.
- FLANGE BOLTS SHALL BE TIGHTENED BY THE RCSC.
- THE "TURN-OF-THE-NUT" TIGHTENING.
- SPRUE BOLTS AND ALL OTHER BOLTS IN BEARING TYPE CONNECTIONS SHALL BE TIGHTENED TO A SNUG-TIGHT CONDITION. THE SNUG-TIGHT CONDITION IS DEFINED AS THE TIGHTNESS ATTAINED BY EITHER A FEW IMPACTS OF AN IMPACT WRENCH OR THE FULL EFFORT OF AN IRONWORKER WITH AN ORDINARY SPRUE WRENCH TO BRING THE CONNECTED PILES INTO FIRM CONTACT.
- FOR THREADED ROD CONNECTIONS, TRIM EXCESS THREADED ROD TO NO MORE THAN 3" PAST THE NUT AND COAT WITH ZINGA COLD GALVANIZING COMPOUND.

**VERIFICATION AND INSPECTION**

- IF APPLICABLE, VERIFICATION INSPECTION TO BE PERFORMED SHALL BE IN ACCORDANCE TO IRC-2018 SECTION 1705.2 FOR STEEL CONSTRUCTION AND TABLE 1705.3 FOR CONCRETE CONSTRUCTION.

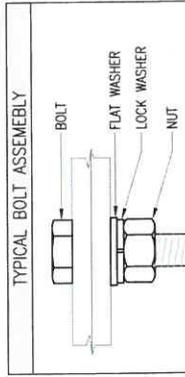

**NOTES**

- ALL DIMENSIONS REPRESENTED IN THIS SHEET ARE AISC MINIMUM REQUIREMENTS. CONTRACTOR SHALL VERIFY EXISTING CONDITIONS IN FIELD AND NOTIFY ENGINEER IF DISTANCES ARE LESS THAN THOSE PROVIDED.
- THE DIMENSIONS PROVIDED ARE MINIMUM REQUIREMENTS. ACTUAL DIMENSIONS OF PROPOSED MEMBERS WITHIN THESE DRAWINGS MAY VARY FROM THE AISC MINIMUM REQUIREMENTS. SHORT SLOT HOLES SHALL ONLY BE USED WHEN DEPICTED IN THE DRAWINGS.
- MATCH EXISTING GAGES WHEN APPLICABLE. UNLESS MINIMUM

**TABLE 8.2 NUT ROTATION FROM SNUG-TIGHT CONDITION FOR TURN-OF-NUT PRETENSIONING<sup>a,b</sup>**

BOLT LENGTH	DISPOSITION OF OUTER FACE OF BOLTED PARTS	
	BOTH FACES NORMAL TO BOLT AXIS	BOTH FACES SLOPED NORMAL TO BOLT AXIS
NOT MORE THAN 4d <sub>b</sub>	1/3 TURN	1/2 TURN
MORE THAN 4d <sub>b</sub> BUT NOT MORE THAN 8d <sub>b</sub>	1/2 TURN	2/3 TURN
MORE THAN 8d <sub>b</sub> BUT NOT MORE THAN 12d <sub>b</sub>	2/3 TURN	5/6 TURN
	5/6 TURN	1 TURN

<sup>a</sup> NUT ROTATION IS RELATIVE TO BOLT REGARDLESS OF THE ELEMENT (NUT OR BOLT) BEING TURNED. FOR REQUIRED NUT ROTATIONS OF 1/2 TURN AND LESS, THE TOLERANCE IS PLUS OR MINUS 30 DEGREES; FOR REQUIRED NUT ROTATIONS OF 2/3 TURN AND MORE, THE TOLERANCE IS PLUS OR MINUS 45 DEGREES.

<sup>b</sup> APPLICABLE ONLY TO JOINTS IN WHICH ALL MATERIAL WITHIN THE GRIP IS STEEL.

<sup>c</sup> WHEN THE BOLT LENGTH EXCEEDS 12d<sub>b</sub>, THE REQUIRED NUT ROTATION SHALL BE DETERMINED BY ACTUAL TESTING IN A SUITABLE TENSION CALIBRATOR THAT SIMULATES THE CONDITIONS OF SMOOTH FITTING STEEL.


<sup>d</sup> BEVELED WASHER NOT USED.

SPECIFICATION FOR STRUCTURAL JOINTS USING ASTM A325 OR A490 BOLTS, JUNE 30, 2004 RESEARCH COUNCIL ON STRUCTURAL CONNECTIONS

BOLT DIAMETER	NOMINAL HOLE DIMENSIONS	
	STANDARD HOLE	SHORT SLOT
1/2"	9/16"	9/16" x 11/16"
5/8"	11/16"	11/16 x 7/8"
3/4"	13/16"	13/16" x 1"
7/8"	15/16"	15/16" x 1 1/8"
1"	1 1/16"	1 1/16" x 1 5/16"

BOLT DIAMETER	BOLT EDGE AND SPACING	
	MIN EDGE	SPACING
1/2"	3/8"	1 1/2"
5/8"	1 1/8"	1 7/8"
3/4"	1 1/4"	2 1/4"
7/8"	1 1/2"	2 5/8"
1"	1 3/4"	3"

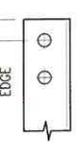

ANGLE SIZE	WORKABLE GAGES	
	MIN.	EDGE
1 3/4"	1"	
2"	1 1/8"	
2 1/2"	1 3/8"	
3 1/2"	2"	
4"	2 1/2"	



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CUSTOMER SITE NAME:  
SAMUEL\_PARK


1101 E MAIN ST.  
MESQUITE, TX 75149


TOWER ENGINEERING SOLUTIONS, LLC  
TEMS REGISTERED ENGINEERING FIRM  
1-1988

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1 FIRST ISSUE	MC 08/26/23
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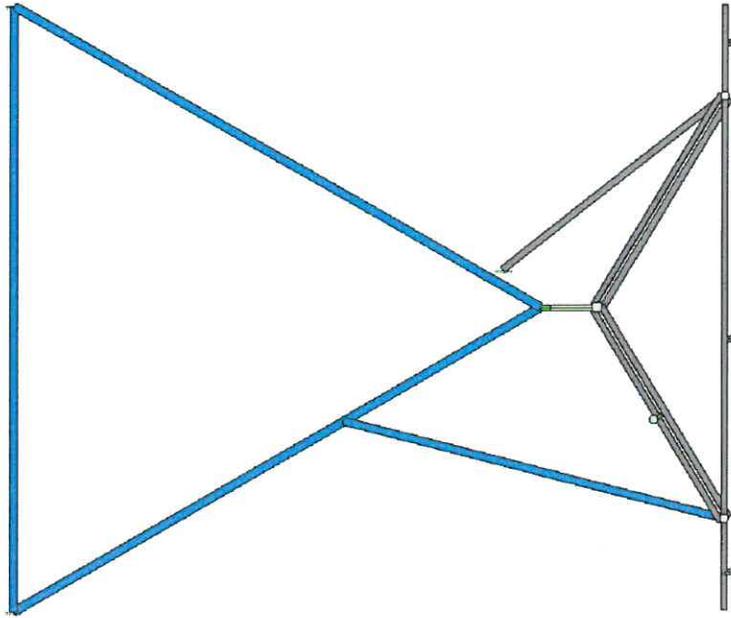
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CUSTOMER SITE NAME: SAMUEL_PARK	
1101 E MAIN ST MESQUITE, TX 75148	
TOWER ENGINEERING SOLUTIONS, LLC TOWER REGISTERED ARCHITECTURE FIRM F-15886	
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△	
△	
△	
△	
SHEET TITLE: CLIMBING FACILITY DETAILS	
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PICTURE OF SAFETY CLIMB

NO SAFETY CABLE OBSERVED IN THE TOWER

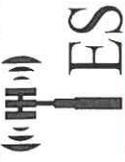

NOTE:  
 1. INSTALL SHALL NOT CAUSE HARM TO THE STRUCTURE, CLIMBING FACILITY, SAFETY CLIMB OR ANY SYSTEM INSTALLED ON THE STRUCTURE.

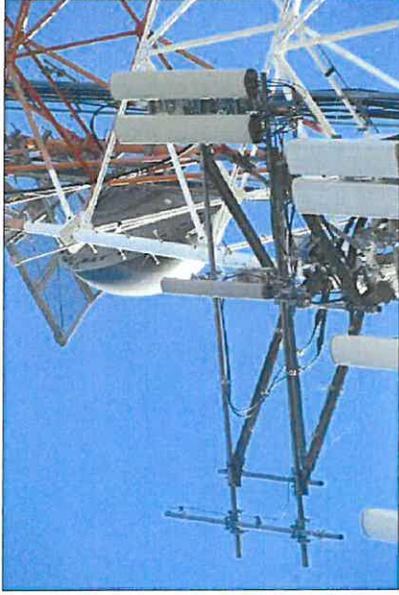**MOUNT MODIFICATION SCHEDULE**


SL. NO.	MOUNT MODIFICATION DESCRIPTION	REFERENCE SHEET NO.
1	INSTALL NEW PERFECT VISION MICROWAVE STRUT SUPPORT FACE MOUNT KIT (PV-MD-CS-1BR)	SS-2
2	INSTALL NEW TIE BACK PIPE.	SS-3
3	INSTALL NEW VZW SMART ANGLE TO ANGLE CROSSOVER	VZW SMART-MSK7, SS-5
4	INSTALL NEW 2" PST RAYCAP MOUNT PIPE (P40-238X072), (1) FOR (2) SECTOR ONLY	VZW SMART-PIPE, SS-1, SS-5

FIELD CUTTING AND FIELD DRILLING MAY BE NECESSARY TO ACHIEVE THE REQUIRED DIMENSIONS FOR THREADED ROD CONNECTIONS. TRIM EXCESS THREADED ROD TO NO MORE THAN 3" PAST THE NUT AND COAT WITH ZINGA COLD GALVANIZING COMPOUND.

IF EXISTING TOWER IS PAINTED, CONTRACTOR TO VERIFY WITH TOWER OWNER IF NEW MODIFICATION MEMBERS ARE TO BE PAINTED TO MATCH EXISTING TOWER COLOR.

THE CONTRACTOR SHALL BE RESPONSIBLE FOR THE CLEANUP, REMOVAL AND DISPOSAL OF EXCESS MATERIALS USED AND REMOVED FROM THE STRUCTURE AT THE COMPLETION OF THE PROJECT.

**MEMBERS IN BLUE COLOR ARE NEW REINFORCEMENTS AND MEMBERS IN AQUA COLOR (IF SHOWN) ARE RELOCATED MEMBERS**

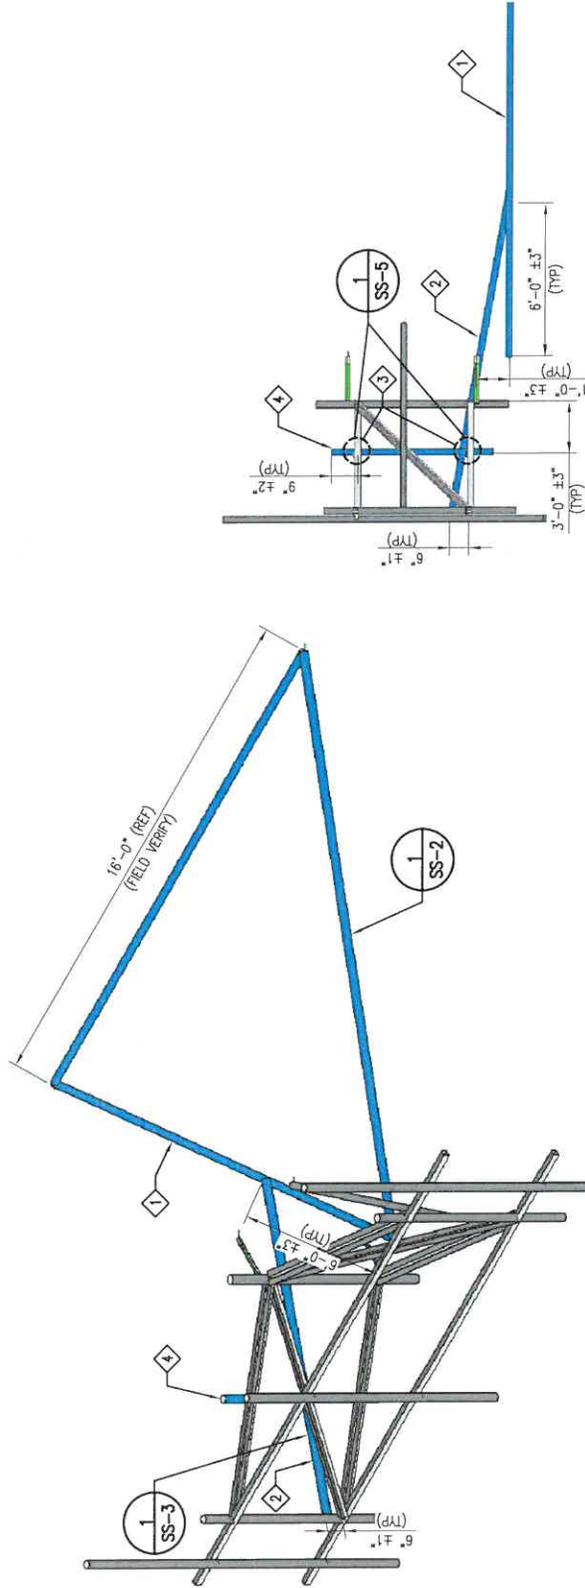

**1** ISOMETRIC VIEW  
**SS-1** EXISTING ANTENNA MOUNT @ 124' ELEV.  
 (MODIFICATION IS TYPICAL FOR ALL (3) SECTORS)

**2** SIDE VIEW  
**SS-1**

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TES JOB NO:  
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CUSTOMER SITE NO:  
 104821-YZW

CUSTOMER SITE NAME:  
 SAMUEL PARK

1101 E MAIN ST  
 MESQUITE, TX 75149

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 TEXAS REGISTERED ENGINEERING FIRM  
 E-15386


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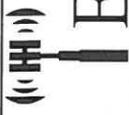
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**ANTENNA MOUNT  
 MODIFICATION DETAILS**

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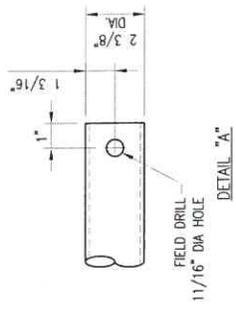
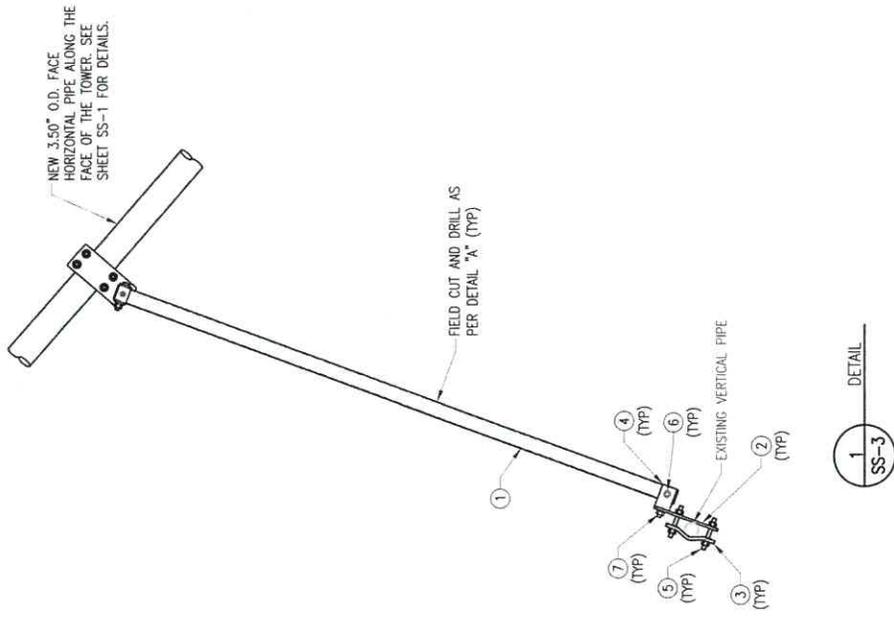
TOWER HEIGHT: 100 FT  
TOWER WEIGHT: 1000 LBS  
TOWER FOOTING: 1000 LBS

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1	FIELD ISSUE	MC	09/26/21

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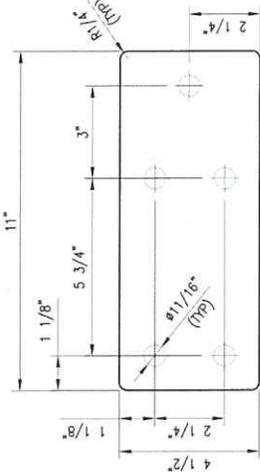
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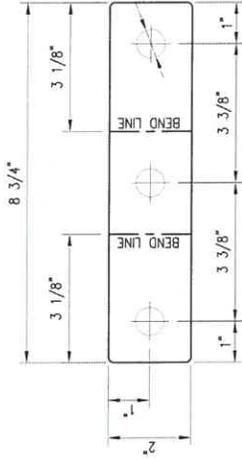


ITEM NO.	QTY.	PART NO.	DESCRIPTIONS
1	3	P40-238X174	PIPE 2 SCH40 (2.375\"/>
2	6	PL375-4511	PL 3/8\"/>

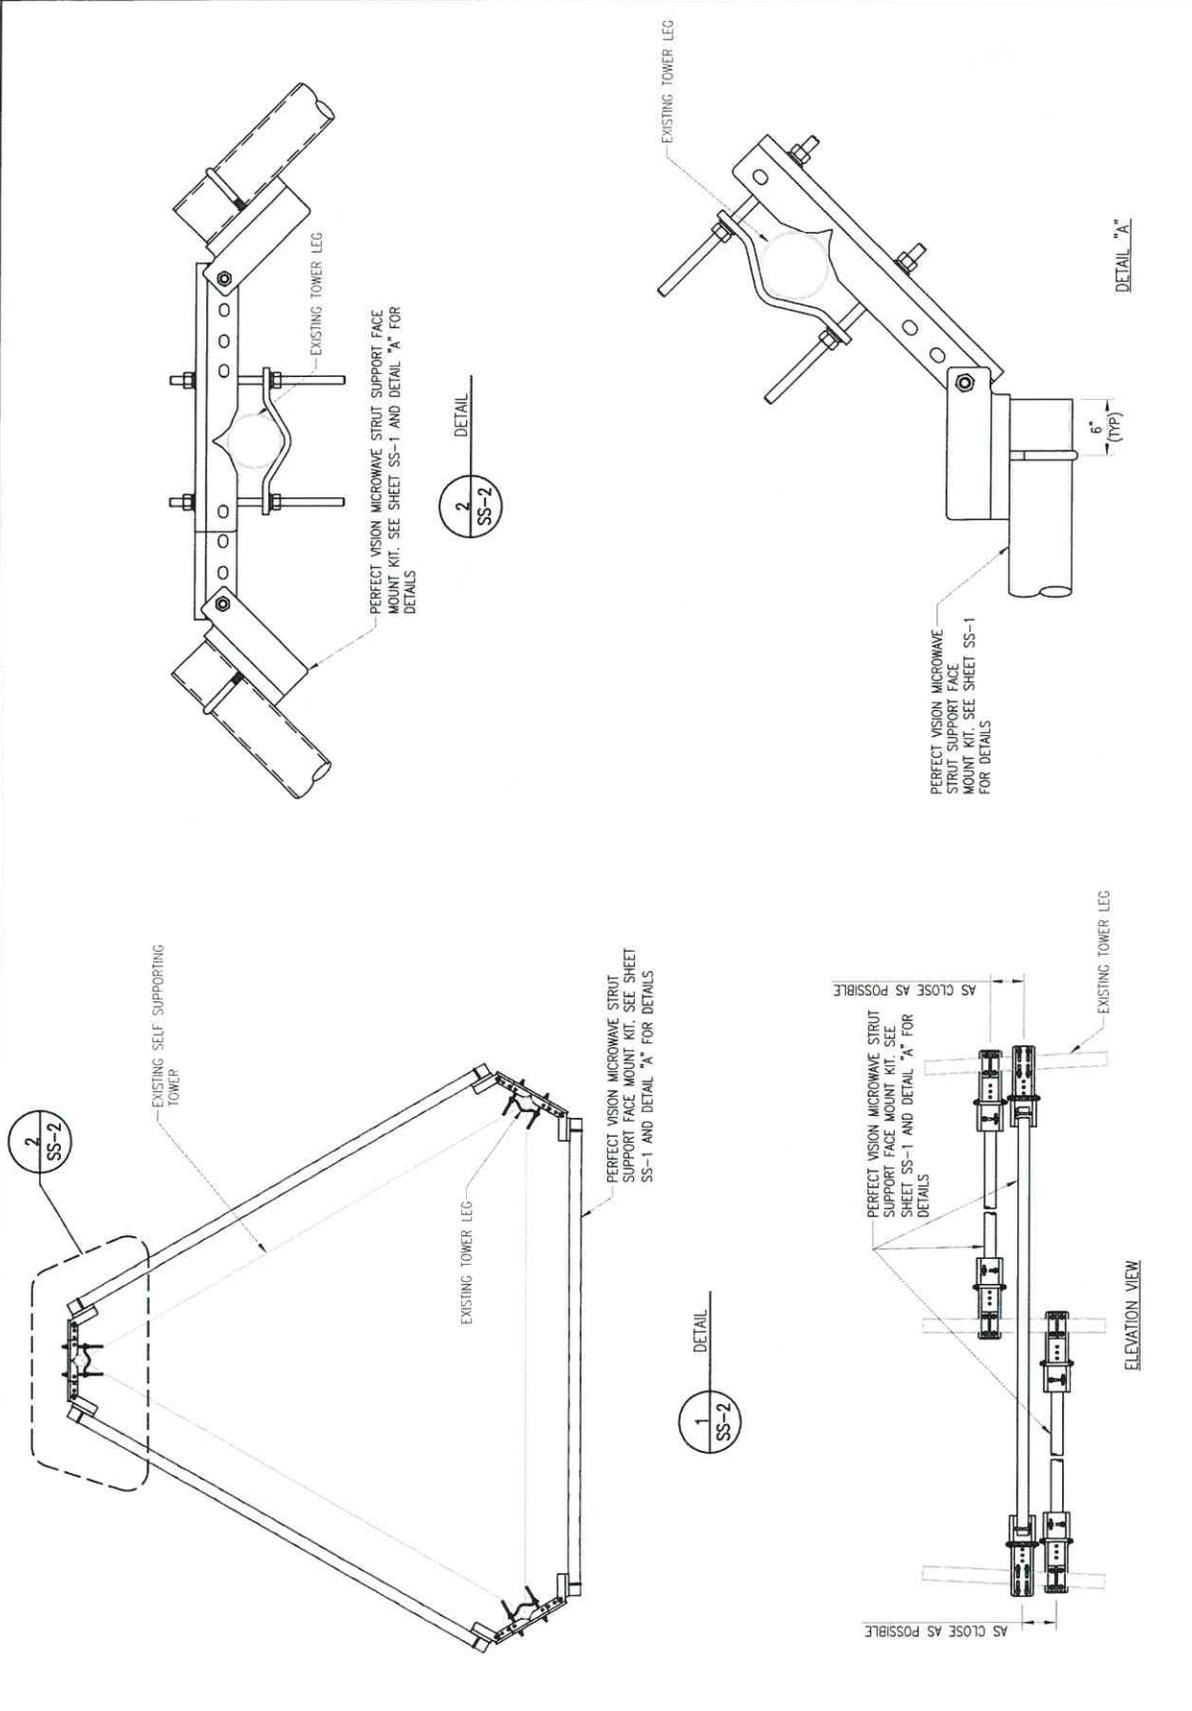1  
SS-3  
DETAIL




PL 3/8" X 4 1/2" X 11" A36  
(3.64 LBS)




BEFORE BENDING


BP2-875  
PL 1/4" X 2" X 8 3/4" A36 BENT PLATE  
(1.27 LBS)

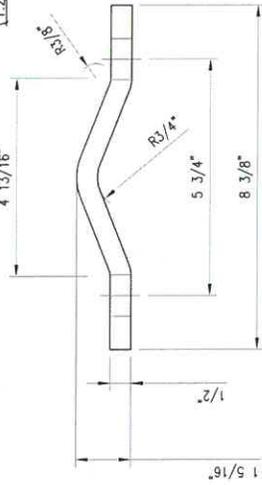


V-CLAMP  
TOP VIEW

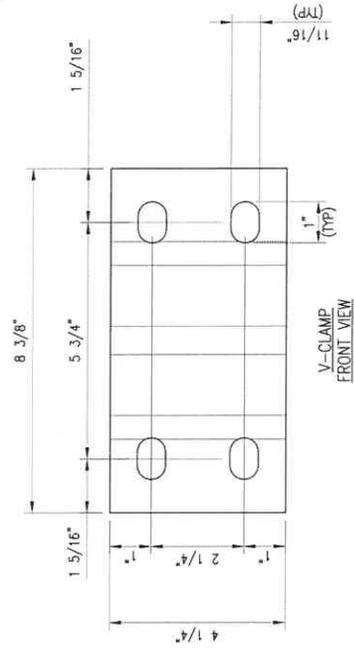

V-CLAMP  
FRONT VIEW

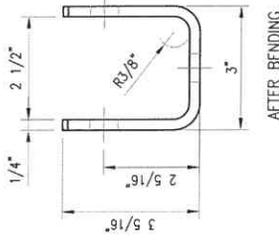

AFTER BENDING

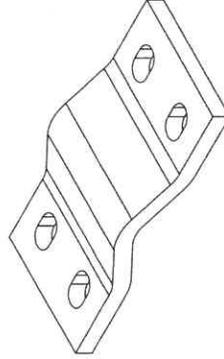

V-CLAMP  
ISOMETRIC VIEW

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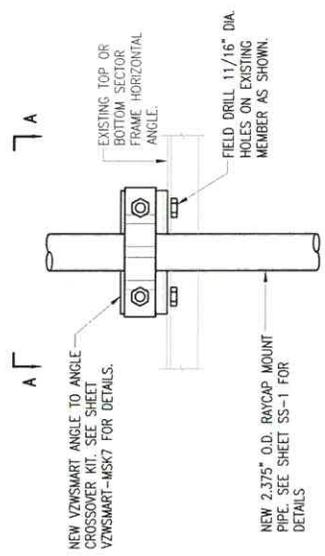
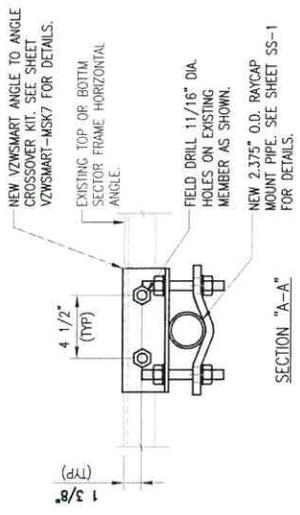
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 DATE: 08/26/21  
 IES APPROVED CAPTION: JES  
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1  
 SS-5  
 DETAIL

**NOTE:**  
EXISTING RRIS/EQUIPMENT MAY BE RELOCATED  
ALONG THE MEMBER TO ACCOMMODATE THE  
INSTALLATION OF NEW MOUNT MODIFICATION

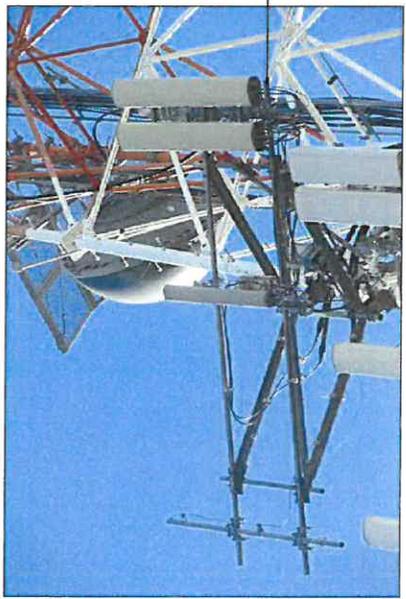


PHOTO 1



PHOTO 2

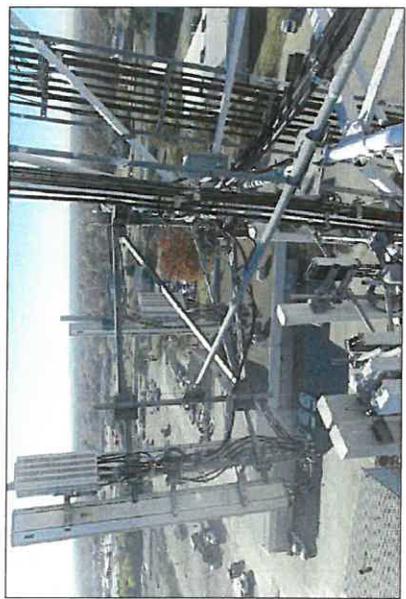


PHOTO 3



PHOTO 4

Tower Engineering Solutions  
1320 GREENWAY PARK, SUITE 600  
IRVING, TX 75038  
PH: (972) 483-3687

IES JOB NO:  
10096019  
CUSTOMER SITE NO:  
104821-VZW  
CUSTOMER SITE NAME:  
SAMUEL PARK  
1101 E MAIN ST  
MESQUITE, TX 75149

TOWER ENGINEERING SOLUTIONS, LLC  
1045 HAWKING PARK  
F-1588


DRAWN BY: MC	CHECKED BY: RK/SK
REV.	DESCRIPTION
BY	DATE
MC	08/26/21
MC	08/26/21
MC	
MC	
MC	

SHEET TITLE:  
**MOUNT PHOTOS**

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SHEET NUMBER: **SS-6**  
REV #: **0**

THE FOLLOWING DRAWINGS ARE INCLUDED FOR REFERENCE ONLY  
PLEASE REFER TO THE INSTALLATION DRAWINGS FOR ACTUAL INSTALLATION DETAILS

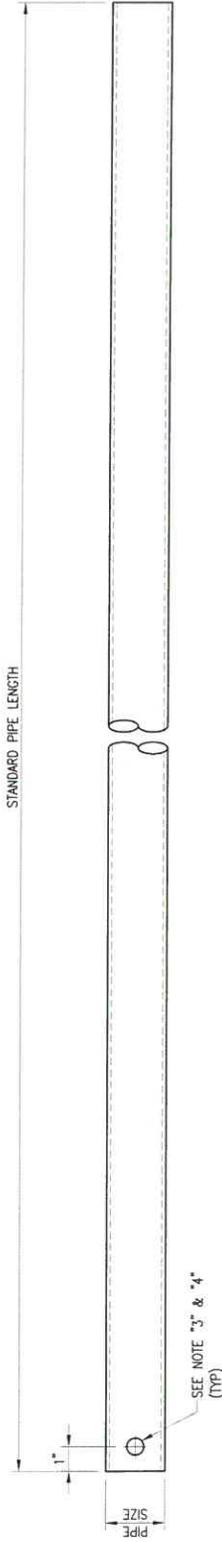

VZWSMART Standard Pipe		
VZWSMART Number	Size	Length
P40-238X048	PIPE 2 SCH40 (2.375" OD x 0.154" THK)	48"
P40-238X072	PIPE 2 SCH40 (2.375" OD x 0.154" THK)	72"
P40-238X096	PIPE 2 SCH40 (2.375" OD x 0.154" THK)	96"
P40-238X120	PIPE 2 SCH40 (2.375" OD x 0.154" THK)	120"
P40-238X126	PIPE 2 SCH40 (2.375" OD x 0.154" THK)	126"
P40-238X150	PIPE 2 SCH40 (2.375" OD x 0.154" THK)	150"
P40-238X174	PIPE 2 SCH40 (2.375" OD x 0.154" THK)	174"
P40-278X048	PIPE 2.5 SCH40 (2.875" OD x 0.203" THK)	48"
P40-278X072	PIPE 2.5 SCH40 (2.875" OD x 0.203" THK)	72"
P40-278X096	PIPE 2.5 SCH40 (2.875" OD x 0.203" THK)	96"
P40-278X120	PIPE 2.5 SCH40 (2.875" OD x 0.203" THK)	120"
P40-278X126	PIPE 2.5 SCH40 (2.875" OD x 0.203" THK)	126"
P40-278X150	PIPE 2.5 SCH40 (2.875" OD x 0.203" THK)	150"
P40-278X174	PIPE 2.5 SCH40 (2.875" OD x 0.203" THK)	174"
P40-312X048	PIPE 3 SCH40 (3.5" OD x 0.216" THK)	48"
P40-312X072	PIPE 3 SCH40 (3.5" OD x 0.216" THK)	72"
P40-312X126	PIPE 3 SCH40 (3.5" OD x 0.216" THK)	126"
P40-312X150	PIPE 3 SCH40 (3.5" OD x 0.216" THK)	150"


**NOTE:**  
 APPROVED SMART KIT VENDORS ARE ALLOWED TO SUBSTITUTE AT THEIR DISCRETION  
 PIPES LISTED ON THIS PAGE FOR CUSTOM LENGTH COMPONENTS OF MATCHING SIZE.  
 SUBSTITUTIONS SHALL MEET THE ORIGINAL STRUCTURAL INTENT.

**NOTES:**  
 1. ALL DIM. COMP. AS-BUILT NO BETTER


DRAWN BY: BT	CHECKED BY: HMA/KW
REV. DESCRIPTION	BY DATE
1 FIRST ISSUE	BT 08/04/21
2	
3	
4	
SHEET TITLE:	

VZWSMART  
 STANDARD PIPE

DATE BY: DA	CHECKED BY: BT/WK
REV	DESCRIPTION
BY: SKT	DATE: 05/06/20
LAST ISSUE	BY: SKT
NO. OF ISSUES	DATE: 05/06/20
NO. OF SHEETS	
SHEET TITLE	
VZWSMART-MSK7 ANGLE TO ANGLE CROSSOVER KIT	
SHEET NUMBER	REV #
VZWSMART-MSK7	1

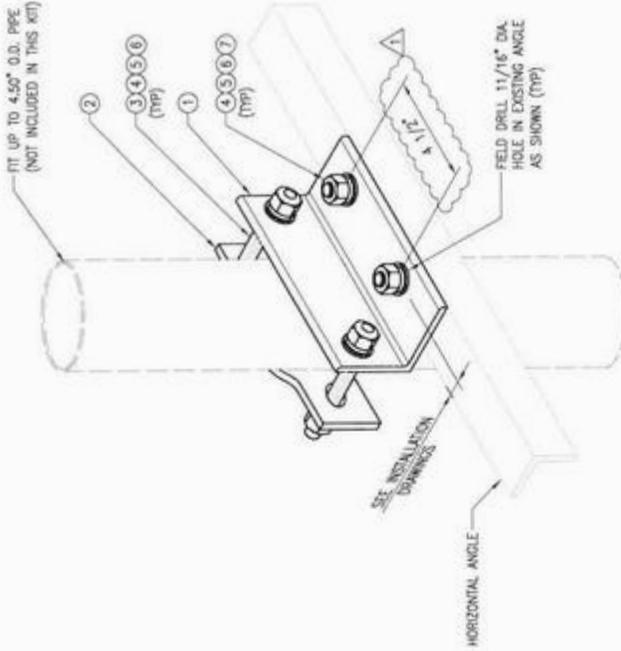

OPTION 2

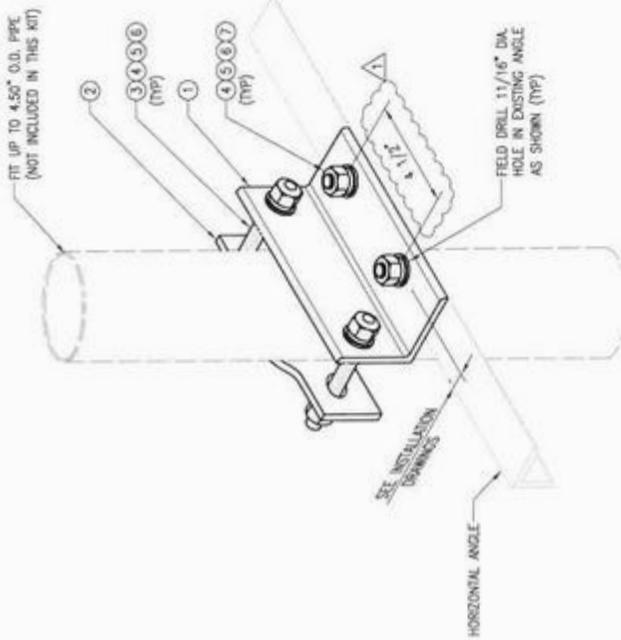

OPTION 1

ANGLE TO ANGLE CROSSOVER KIT

VZWSMART-MSK7 (ANGLE TO ANGLE CROSSOVER KIT)					
ITEM NO.	QTY.	PART NO.	DESCRIPTION	SHEET #	WT
1	1	L3325-0.7	1. 3" X 3" X 1/4" X 0"-8" A36	MSK7-F2	3.33
2	1	HCP	PL 1/2" X 2" X 6 5/8" A36 BENT PLATE	MSK7-F1	2.4
3	2	----	BOLT 5/8" DIA. X 6" FULL THREAD SAE GR 5	----	----
4	4	NUT-625	5/8" HOG HEX NUT	----	0
5	6	FW-625	5/8" HOG USS FLAT WASHER	----	0
6	4	LW-625	5/8" HOG LOCK WASHER	----	0
7	2	----	BOLT 5/8" X 2" A325	----	0
				GALVANIZED WT	7

- NOTES:
- HOT-DIPPED GALVANIZED PER ASTM A123.
  - USE PROVIDED ADDITIONAL FLAT WASHERS FOR CONNECTING TO 3/16" THICK HORIZONTAL ANGLE.

## ATTACHMENT B-6

### Equipment Compound and Antenna Facilities

Equipment Compound and Shelter: 11'-8" x 16' area identified as the Licensee's Shelter on Attachment A-2(C) and A-3.

#### Antenna Facilities:

Type: (6) Amphenol CWWX063X25G00 Antennas  
(3) Amphenol W85-19-X28-T2-1920 Antennas  
(3) Samsung L-SUB 6 MT6407-77A Antennas  
(3) B2/B66A RRH BR049  
(3) B5/B13 RRH BR04C  
(1) 12-OVP Tower  
(2) 6-OVP Tower  
(2) 6-OVP Shelter  
(3) Amphenol MKS09T07TWIN mounts

Centerline Height: 121-124'

Cables: (6) 1-5/8" Coax Cables  
(1) 12 x 24 Hybriflex Cable  
(2) 6 x 12 Hybriflex Cables  
(3) 1/4" Homerun RET Cables

Fiber Junction Box and 4" Fiber Conduit