CITY OF MESQUITE, TEXAS STREET REPAIRS FOR **ALLEY RECONSTRUCTION** CITY CONTRACT NO. 2024-006




Real. Texas. Service.

CITY OFFICIALS

DANIEL ALEMAN, JR. **MAYOR** JEFF CASPER **DISTRICT 1 KENNY GREEN DISTRICT 2** JENNIFER VIDLER **DISTRICT 3 TANDY BOROUGHS DISTRICT 4 B.W. SMITH DISTRICT 5 DEBBIE ANDERSON DISTRICT 6**

CLIFF KEHELEY CURTIS CASSIDY, P.E., CFM

CITY MANAGER PUBLIC WORKS DIRECTOR

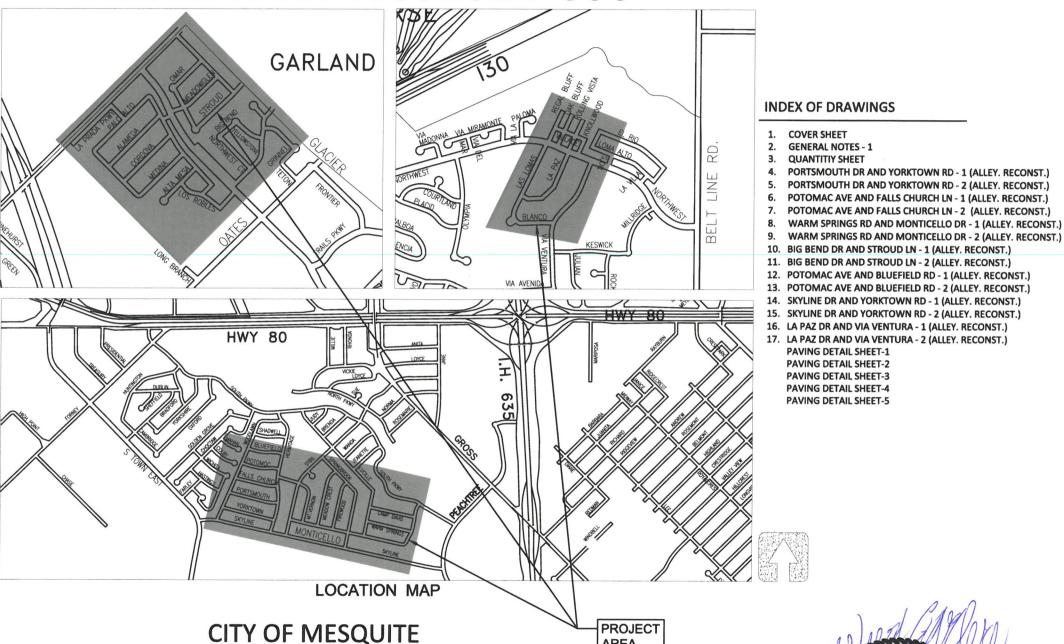



Public Works Department - Engineering Division 1515 N. Galloway Ave. P.O. Box 850137 Mesquite, TX 75149 Ph: 972-216-6955

OCT 2023



PAVING DETAIL SHEET-1 PAVING DETAIL SHEET-2 PAVING DETAIL SHEET-3 PAVING DETAIL SHEET-4 PAVING DETAIL SHEET-5

AREA

GENERAL NOTES FOR CONSTRUCTION ACTIVITIES

- ALL WORK SHALL CONFORM TO THE CITY OF MESQUITE'S GENERAL DESIGN STANDARDS. IN THE EVENT AN ITEM OF WORK IS 21. NOT COVERED IN THE PLANS OR THE CITY OF MESQUITE GENERAL DESIGN STANDARDS. THE MOST CURRENT NORTH CENTRAL TEXAS COUNCIL OF GOVERNMENTS (NCTCOG) STANDARD SPECIFICATIONS FOR PUBLIC WORKS CONSTRUCTION AND THE MOST CURRENT VERSION OF TEXAS DEPARTMENT OF TRANSPORTATION STANDARD SPECIFICATIONS FOR CONSTRUCTION AND MAINTENANCE OF HIGHWAYS, STREETS, AND BRIDGES SHALL APPLY WITH CONCURRING NOTIFE TO THE CITY ENGINEER AND THE PROJECT ENGINEER. THE CITY ENGINEER SHALL HAVE FINAL DECISION ON ALL TRUCTION MATERIALS, METHODS, AND PROCEDURES.
- ALL CONTRACTORS AND DEVELOPERS, WITH THEIR EMPLOYEES AND AGENTS, SHALL COMPLY WITH ALL APPLICABLE FEDERAL, STATE AND LOCAL SAFETY LAWS AND REGULATIONS, INCLUDING BUT NOT LIMITED TO THE OCCUPATIONAL SAFETY AND HEALTH ACT OF 1970, AND ORDINANCES RULES. REGULATIONS AND ORDERS OF ANY PUBLIC AUTHO HAVING JURISDICTION FOR THE SAFETY OF PERSONS OR PROPERTY TO PROTECT THEM FROM DEATH, INJURY, DAI
- ALL COMMUNICATION BETWEEN THE CITY AND THE CONTRACTOR SHALL BE THROUGH THE ENGINEERING CONSTRUCTION INSPECTOR AND CITY ENGINEER ONLY. IT IS THE RESPONSIBILITY OF THE CONTRACTOR TO CONTACT THE APPROPRIATE DEPARTMENT FOR INSPECTIONS OF WORK NOT FALLING UNDER THE ENGINEERING CONSTRUCTION PERMIT.
- PRIOR TO CONSTRUCTION, CONTRACTOR SHALL HAVE IN THEIR POSSESSION ALL NECESSARY PERMITS, PLANS, LICENSES, ETC. CONTRACTOR SHALL HAVE AT LEAST ONE SET OF APPROVED ENGINEERING PLANS AND SPECIFICATIONS ON-SITE AT
- IT IS THE CONTRACTOR'S RESPONSIBILITY TO NOTICY LITH ITY COMPANIES TO APPANGE FOR EYACT LOCATIONS AT LEAST IT IS THE CONTRACTOR'S RESPONSIBILITY TO NOTIFY UTILITY COMPANIES TO ARRANGE FOR EXACT LOCATIONS AT LEAST 48 HOURS PRIOR TO BEGINNING CONSTRUCTION. THE COMPLETENESS AND ACCURACY THE UTILITY DATA SHOWN ON THE PLANS IS NOT GUARANTEED. THE CONTRACTOR IS RESPONSIBLE FOR VERIFYING THE DEPTH AND LOCATION OF EXISTING UNDERGROUND UTILITIES PRIOR TO EXCAVATING, TRENCHING, OR DRILLING AND SHALL BE REQUIRED TO TAKE ANY PRECAUTIONARY MEASURES TO PROTECT ALL LINES SHOWN AND / OR ANY OTHER UNDERGROUND UTILITIES NOT ON RECORD OR NOT SHOWN ON THE PLANS. THE CONTRACTOR WILL BE RESPONSIBLE FOR DAMAGES TO UTILITIES IF THE DAMAGE IS CAUSED BY NEGLIGENCE OR FAILURE TO HAVE LOCATES PERFORMED
 - TEYAS 811
 - CITY OF MESQUITE UTILITIES CITY OF MESQUITE TRAFFIC
 - 972-216-6940
- VERIFICATION OF THE CONDITION OF EXISTING CITY UTILITIES PRIOR TO CONNECTIONS SHALL BE THE RESPONSIBILITY OF THE CONTRACTOR. THE CONTRACTOR SHALL REQUEST FOR LINE LOCATES AS DIRECTED IN ITEM #
- CONTRACTOR SHALL LOCATE AND PROTECT ALL EXISTING LANDSCAPE IRRIGATION SYSTEMS. DAMAGE TO EXISTING IRRIGATION SYSTEMS SHALL BE RESTORED TO EQUAL OR BETTER CONDITION BY A LICENSED IRRIGATOR AT THE CONTRACTOR'S EXPENSE.
- CONTRACTOR SHALL BE RESPONSIBLE FOR ANY DAMAGE TO EXISTING FACILITIES OR ADJACENT PROPERTIES DURING CONSTRUCTION. ANY REMOVAL OR DAMAGE TO EXISTING FACILITIES OR ADJACENT PROPERTIES SHALL BE REPLACED OR REPAIRED TO EQUAL OR BETTER CONDITION BY THE CONTRACTOR. THE CONTRACTOR SHALL COORDINATE ALL REPAIRS TO PRIVATE PROPERTY WITH THE PROPERTY OWNER. CONTRACTOR SHALL PAY AND/OR SETTLE WITH PRIVATE PROPERTY OWNER FOR ALL COSTS RELATED TO ANY DAMAGE. FOR MORE DETAIL, REFER TO NCTCOG 107.24.
- TESTING AND INSPECTION OF MATERIALS SHALL BE PERFORMED BY A COMMERCIAL TESTING LABORATORY APPROVED BY THE CITY. CONTRACTOR SHALL FURNISH MATERIALS OR SPECIMENS FOR TESTING, AND SHALL FURNISH SUITABLE EVIDENCE THAT THE MATERIALS PROPOSED TO BE INCORPORATED INTO THE WORK ARE IN ACCORDANCE WITH THE SPECIFICATIONS. ALL TESTING AND RE-TESTING COSTS SHALL BE THE RESPONSIBILITY OF THE CONTRACTOR. FOR MORE
- CONTRACTOR SHALL NOTIFY THE CITY AT LEAST 48 HOURS PRIOR TO BEGINNING ANY CONSTRUCTION.
- 11. ALL SHOP DRAWINGS, WORKING DRAWINGS OR OTHER DOCUMENTS WHICH REQUIRE REVIEW BY THE CITY SHALL BE SUBMITTED BY THE CONTRACTOR SUFFICIENTLY IN ADVANCE OF SCHEDULED CONSTRUCTION TO ALLOW NO LESS THAN 10
- CONTRACTOR SHALL BE RESPONSIBLE FOR ALL REQUIRED CONSTRUCTION SURVEYING AND STAKING AND SHALL NOTIFY THE CITY OF ANY DISCREPANCIES PRIOR TO PROCEEDING WITH ANY WORK, FOR MORE DETAIL, REFER TO NCTCOG 105.4
- 13 CONTRACTOR SHALL BE RESPONSIBLE FOR PROTECTING ALL SLIRVEY MARKERS INCLUDING IRON RODS. PROPERTY CORNERS, OR SURVEY MONUMENTS WITHIN THE LIMITS OF CONSTRUCTION AND OUTSIDE RIGHT-OF-WAY DURING CONSTRUCTION. ANY SURVEY MARKERS DISTURBED DURING CONSTRUCTION SHALL BE REPLACED BY THE CONTRACTOR
- CONTRACTOR SHALL NOT STORE MATERIALS, EQUIPMENT OR OTHER CONSTRUCTION ITEMS ON ADJACENT PROPERTIES OR RIGHT-OF-WAY WITHOUT THE PRIOR WRITTEN CONSENT OF THE PROPERTY OWNER AND THE CITY. THE PROJECT SHALL NOT BE ACCEPTED UNTIL THE CONTRACTOR PROVIDES A LETTER FROM THE PROPERTY OWNER STATING THEY ARE SATISFIED WITH THE CONDITION OF THE PROPERTY.
- UNUSABLE EXCAVATED MATERIAL OR CONSTRUCTION DEBRIS SHALL BE REMOVED AND DISPOSED OF OFFSITE AT AN APPROVED DISPOSAL FACILITY BY THE CONTRACTOR.
- 16. ALL SIGNAGE SHALL BE INSTALLED IN ACCORDANCE WITH THE LATEST EDITION OF THE TEXAS MANUAL ON UNIFORM

GENERAL NOTES FOR EROSION CONTROL/STORM WATER POLLUTION PREVENTION

- THE CONTRACTOR SHALL COMPLY WITH THE CITY OF MESQUITE'S STORM WATER ORDINANCE, THE TOPES GENERAL CONSTRUCTION PERMIT TXR150000 AND ANY OTHER STATE AND/OR LOCAL REGULATIONS
- CONTRACTOR IS RESPONSIBLE FOR KEEPING STREETS AND DRIVEWAYS ADJACENT TO THE PROJECT FREE OF MUD AND DEBRIS AT ALL TIMES. CONTRACTOR SHALL CLEAN UP AND REMOVE ALL LOOSE MATERIAL RESULTING FROM CONSTRUCTION OPERATIONS. STOCKPILING OR STAGING OF MATERIALS WILL NOT BE ALLOWED IN RIGHT-OF-WAY WITHOUT PRIOR AUTHORIZATION. THE CONTRACTOR SHALL TAKE ALL AVAILABLE PRECAUTIONS TO CONTROL DUST, ANY DIRT, MUD OR DEBRIS TRACKED OFFSITE SHALL BE CLEANED UP BY THE CONTRACTOR IMMEDIATELY.
- ALL EROSION CONTROL DEVICES SHOWN ON THE PLANS RELEASED FOR CONSTRUCTION SHALL BE INSTALLED IN ALL EROSION CONTROL DEVICES SHOWN ON THE PLANS RELEASED FOR CONSTRUCTION SHALL BE INSTALLED IN ACCORDANCE WITH THE SWIPPP SEQUENCING PRIOR TO COMMENCING ANY EARTH DISTURD ACTIVITIES, FAILURE TO INSTALL THE EROSION CONTROL DEVICES BEFORE STARTING THE EARTH DISTURBING ACTIVITIES MAY RESULT IN SANCTIONS INCLUDING, BUT NOT LIMITED TO, WITHHOLDING OF RELEASE OF CONSTRUCTION PERMITS, INSPECTIONS, PAYMENT OF CITY FUNDED PORTIONS OF THE PROJECT, SUSPENSION OF CONSTRUCTION ACTIVITIES, OR CITATIONS, EROSION CONTROL DEVICES SHALL BE INSTALLED AND MAINTAINED IN COMPLIANCE WITH THE PROJECT PLANS, CITY STORMWATER ORDINANCE AND/OR SWPPP AND CONSTRUCTION GENERAL PERMIT. THE CONTRACTOR SHALL INSPECT THE SITE DAILY AND KEEP THE SITE FREE OF TRASH AND CONSTRUCTION DEBRIS
- CONTRACTOR MUST EXECUTE AND KEEP A COPY OF THE CONSTRUCTION SITE NOTICE (CSN) FOR THOSE ACTIVITIES DISTURBING MORE THAN 1 ACRE AND A NOTICE OF INTENT (NOI) FOR THOSE ACTIVITIES DISTURBING 5 ACRES OR MORE.

GENERAL NOTES FOR TRAFFIC CONTROL:

- CONTRACTOR SHALL PROVIDE THE PROJECT ENGINEER WITH A TRAFFIC CONTROL PLAN AT LEAST 10 BUSINESS DAYS BEFORE ANY WORK ON A CITY STREET. TRAFFIC CONTROL MEASURES SHALL CONFORM TO THE LATEST REVISION OF THE TEXAS MANUAL ON UNIFORM TRAFFIC CONTROL DEVICES (TMUTCD)
- CONTACT TRAFFIC ENGINEERING DIVISION, 972-216-6917, AT LEAST 48 HOURS PRIOR TO WORK REQUIRING THE REMOVAL OR RELOCATION OF TRAFFIC SIGNS, TRAFFIC CONTROL EQUIPMENT OR OTHER TRAFFIC CONTROL APPURITEMANCES, ONLY CITY TRAFFIC PERSONNEL SHALL REMOVE TRAFFIC SIGNS.
- 23. IN THE EVENT THE CONSTRUCTION WORK REQUIRES THE CLOSURE OF AN EXISTING STREET, ALLEY, OR FIRE LANE, THE IN THE EVENT THE CONSTRUCTION WORK REQUIRES THE CLOSURE OF AN EXISTING STREET, ALLEY, OR FIRE LANE, THE CONTRACTOR SHALL REQUIEST THE ROAD CLOSURE THROUGH THE CITY INSPECTOR A MINIMUM OF 48 HOURS IN ADVANCE OF THE REQUESTED CLOSURE. CLOSURES WILL NOT BE ALLOWED PRIOR TO 9:00 A.M. OR AFTER 3:30 P.M. MONDAY THROUGH FRIDAY UNLESS OTHERWISE APPROVED BY THE CITY. IN THE EVENT A DRIVEWAY(S) NEEDS TO BE CLOSED, THE CONTRACTOR SHALL REQUEST THE DRIVEWAY CLOSURE THROUGH THE CITY INSPECTOR, WHO WILL IN TURN NOTIFY DISPATCH AND OTHER PERTINENT CITY DEPARTMENTS. CLOSURES ARE PROHIBITED DURING SCHOOL ZONES TIMES IN AND AROUND SCHOOLS.
- IF THE CONSTRUCTION ZONE AFFECTS THE MOVEMENTS OF PEDESTRIANS, ADEQUATE PEDESTRIAN ACCESS AND WALKWAYS SHALL BE PROVIDED IN ACCORDANCE WITH THE DISABILITIES ACT ACCESSIBILITY GUIDELINES, PROWAG, TAS AND THE TMUTCD. WHERE DEVELOPMENTS OCCUR WITHIN 0.5 MILES OF A SCHOOL SITE, TEMPORARY SIDEWALKS MUST BE CONSTRUCTED CONNECTING THE DEVELOPMENT TO THE SCHOOL SITE. THE ROUTE SHALL BE APPROVED BY THE CITY ENGINEER, TEMPORARY SIDEWALKS MAY BE CONSTRUCTED WITH MATERIALS OTHER THAN CONCRETE THE MATERIAL SHALL BE APPROVED BY THE CITY ENGINEER AND BE AN ALL-WEATHER MATERIAL OF A COLOR AND TEXTURE DISTINCTLY
- OVERNIGHT LANE CLOSURES SHALL BE APPROVED BY CITY PRIOR TO CLOSING THE LANE. ANY LANE OR SHOULDER CLOSURE ON AN ARTERIAL ROAD THAT EXTENDS INTO THE NIGHT SHALL REQUIRE THE MANDATORY USE OF ARROW

GENERAL NOTES FOR PAVING

- 26. ABSOLUTELY NO EARTHWORK, LIME APPLICATION, OR OTHER PREPARATION OF THE SUBGRADE FOR PAVING OF STREETS, ALLEYS, SIDEWALKS, TRAILS, FIRE LANES OR OTHER TRANSPORTATION RELATED FLATWORK SHALL BE INITIATED WITHOUT AUTHORIZATION FROM THE CITY. THE CITY WILL AUTHORIZE THE SUBGRADE WORK IN PREPARATION FOR PAVING AFTER UTILITY TRENCH BACKFILL TESTING HAS BEEN COMPLETED AND VERIFIED TO MEET THE CITY REQUI
- ALL SIDEWALKS SHALL COMPLY WITH THE AMERICANS WITH DISABILITIES ACT AND THE TEXAS ARCHITECTURAL BARRIERS ACT. THE CITY OF MESQUITE HAS NOT REVIEWED THESE PLANS FOR COMPLIANCE WITH THE AMERICANS WITH DISABILITIES ACT, TEXAS ARCHITECTURAL BARRIERS ACT, OR ANY OTHER ACCESSIBILITY LEGISLATION, AND DOES NOT WARRANTY OR APPROVE THESE PLANS FOR ANY ACCESSIBILITY STANDARDS. PRIOR TO PROJECT ACCEPTANCE, THE CONTRACTOR SHALL SUBMIT TO THE CITY DOCUMENTATION THAT THE PROJECT WAS INSPECTED BY A REGISTERED ACCESSIBILITY SPECIAL IST REGISTERED WITH THE TEXAS DEPARTMENT OF LICENSING AND REGULATION CERTIFYING THE PROJECT IS IN COMPLIANCE WITH THE REQUIREMENTS OF THE TEXAS ARCHITECTURAL BARRIERS ACT.
- ALL CONCRETE PAVING (STREETS, ALLEYS, SIDEWALKS, DRIVEWAYS) WITHIN CITY ROW SHALL HAVE A 28 DAY MIN COMPRESSIVE STRENGTH OF 4,000 PSI, CONTAINING A MINIMUM OF 6 SACKS OF CEMENT PER CUBIC YARD, WITH A SLUMP RANGE OF 1" TO 3" SLUMP FOR MACHINE POURS AND 3" TO 5" SLUMP FOR HAND POURS UNLESS OTHERWISE NOTED IN THE GENERAL DESIGN STANDARDS, ALL MATERIALS AND REQUIREMENTS FOR CONCRETE SHALL CONFORM TO THE REQUIREMENT OF THE CURRENT NCTOOD ITEM "PORTLAND CEMENT CONCRETE PAVEMENT" WITH THE EXCEPTION THAT FLY ASH MAY BE SUBSTITUTED FOR UP TO 20% OF THE CEMENT CONTENT REQUIREMENT AT 1 TO 1.25 CEMENT TO 1LY ASH
- 29. ALL CONCRETE MUST BE MECHANICALLY VIBRATED. THE FORMING OF NEW STREET AND ALLEY PAVEMENT IS BY USING THE SLIP FORM METHOD. CONCRETE SHALL BE HAND PLACED AT INTERSECTIONS AND MISCELLANEOUS AREAS.
- TEMPERATURE DURING CONCRETE PLACEMENT
 - ERATURE DURING CONCRETE PLACEMENT:
 THE TEMPERATURE OF CONCRETE AS PLACED SHALL NOT EXCEED 95'F.
 NO CONCRETE SHALL BE PLACED ON A FROZEN SUBGRADE.
 IF THE AMBIENT AIR TEMPERATURE IS LESS THAN 40"F AND DROPPING CONCRETE SHALL NOT BE PLACED.

 - IF CONCRETE IS PLACED AND THERE IS AN ANTICIPATED LOW TEMPERATURE OF LESS THAN 40°F WITHIN 5 DAYS AFTER PLACEMENT THE CONCRETE MUST BE COVERED AND KEPT AT A TEMPERATURE OF NOT LESS THAN 50°F.
 - IN ALL CASES, CONCRETE SHOULD NOT BE KEPT AT A TEMPERATURE OF LESS THAN 50°F FOR A PERIOD OF 5 DAYS
- REINFORCING SHALL CONFORM TO ASTM A 615 AND BE A MINIMUM GRADE OF 60 PER ASTM A 370. REINFORCING STEEL BAR LAPS ARE TO BE 30 BAR DIAMETERS OR 15° PER ACI 318, WHICHEVER IS GREATER, A MINIMUM OF 50% OF REBAR INTERSECTIONS ARE TO BE SECURED WITH TIE WIRE AND SUPPORTED WITH CHAIRS. ALL REINFORCEMENT SHALL BE FREE FROM RUST, SCALE, OIL, PAINT AND OTHER SUBSTANCES WHICH PREVENT BONDING TO THE CONCRETE LIMITES OTHERWISE SPECIFIED, STEEL SHALL BE PLACED AT HALF THE PAVEMENT DEPTH
- WHITE CURING COMPOUND IS TO BE APPLIED, PER MANUFACTURER'S RECOMMENDATIONS, TO ALL EXPOSED CONCRETE SURFACES (INCLUDING BACKS OF CURBS) IMMEDIATELY AFTER COMPLETION OF FINISHING OPERATIONS, PER ASTM C-309, TYPE 2, NCTCOG SECTION 303.2.13.1.1.
- 33. NO VEHICLE TRAFFIC SHALL BE PERMITTED ON NEWLY PAVED AREAS FOR SEVEN DAYS AFTER CONCRETE POUR OR UNTIL
- ALL FILL AND LIME SUBGRADES SHALL BE PLACED IN MAXIMUM 8" COMPACTED LIFTS AND BE COMPACTED TO 95% STANDARD PROCTOR AT A MOISTURE RANGE OF 0% TO 6% OF OPTIMUM MOISTURE. MOISTURE LEVEL MUST BE MAINTAINED, BY WETTING OR APPLICATION OF ASPHALT EMULSION PRIME COAT (0.25 TO 0.50 GAL/SY) IF NECESSARY, UNTIL PLACING OF CONCRETE PAVING.

GENERAL NOTES FOR TRENCHING AND CONFINED SPACE

- ALL EXCAVATION AND TRENCH OPERATIONS SHALL BE CONDUCTED IN ACCORDANCE WITH 29 CODE OF FEDERAL REGULATIONS (CFR), PART 1928, SUBPART P AND ALL OTHER APPLICABLE STATE AND CITY REGULATIONS, PRIOR TO COMMENCING ANY EXCAVATION OR TRENCHING OPERATION, THE CONTRACTOR SHALL SUBMIT TO THE CITY ENGINEER A PLAN SEALED BY A TEXAS LICENSED PROFESSIONAL ENGINEER INDICATING THE INTENDED PROCEDURES TO BE USED BY THE CONTRACTOR TO COMPLY WITH OSHA REQUIREMENTS, SUCH PLAN SHALL FURTHER IDENTIFY THE "COMPETENT PERSON" AS REQUIRED BY PARAGRAPH 1928.65 (1)(X) 11 THAT WILL WORK WITH EACH CREW. AM AFFIDAVIT FROM THE CONTRACTOR INDICATING THE COMPETENT PERSON MUST BE SUBMITTED WITH THE TRENCH SAFETY PLAN TO THE CITY ENGINEER. A COPY OF THE TRENCH SAFETY PLAN MUST BE ON THE JOB AT ALL TIMES. THE CITY RESERVES THE RIGHT TO DENY PAYMENT FOR ANY CONSTRUCTION ACTIVITIES IN EXCAVATIONS OR TRENCHES THAT ARE NOT IN ACCORDANCE WITH THE SUBMITTED PLAN. THE CITY DOES NOT APPROVE OR DISAPPROVE TRENCH SAFETY PLANS, BUT WILL RETAIN A FILE COPY.
- IMPLEMENTATION OF TRENCH SAFETY SHALL COMPLY WITH SURMITTED TRENCH SAFETY DESIGN DLAN SURMIT IMPLEMENTATION OF TRENCH SAFETY SHALL COMPLY WITH SUBMITTED TRENCH SAFETY DESIGN PLAIN, SUBMIT DESIGNATED COMPETENT PERSON WHO WILL BE ON-SITE FULL TIME AND IS CAPABLE OF IDENTIFYING EXISTING AND PREDICTABLE HAZARDS IN SURROUNDING OR WORK CONDITIONS WHICH ARE UNSANITARY, HAZARDOUS, OR DANGEROUS TO EMPLOYEES AND WHO HAS THE AUTHORIZATION TO TAKE PROMPT CORRECTIVE MEASURES TO ELIMINATE THEM. INSTALL, OPERATE, MAINTAIN, ADJUST, AND REMOVE TRENCH SAFETY EQUIPMENT, AND PRECAUTIONS IN ACCORDANCE WITH TRENCH SAFETY DESIGN.
- ALL ENTRY INTO CONFINED SPACES SHALL BE CONDUCTED IN ACCORDANCE WITH 28 CODE OF FEDERAL REGULATIONS (CFR), PART 1910.147 P AND ALL OTHER APPLICABLE STATE AND CITY REGULATIONS. PRIOR TO COMMENCING ANY CONFINED SPACE ENTRY, THE CONTRACTOR SHALL SUBMIT TO THE CITY ENGINEER A COPY OF THE CONFINED SPACE ENTRY PLAN WITH A COMPLETED PERMIT

GENERAL NOTES FOR LITILITIES

ALL WATER AND WASTEWATER MAINS THAT ARE PROPOSED TO BE ABANDONED WITHIN STREET ROW AND LESS THAN 10 FEET IN DEPTH, UNDER ANY MAJOR INTERSECTIONS, OR IN AREAS THAT COULD IMPACT MAJOR INFRASTRUCTURE, SHALL BE ABANDONED BY DRAINING THE EXISTING MAIN AND CUTTING AND FILLING THE EXISTING MAIN WITH GROUT.

REQUIRED TESTING MATERIAL MOISTURE CONTENT: 0% - 6% OF OPTIMUM: DENSITY: 95% OF STANDARD PROCTOR PLACE DENSITY AND WATER CONTENT LIME STABILIZED SUBGRADE - DEPTH **ASTM D-693** VERY 300 LINEAR FEET (1) DEPTH OF STARILIZATION AS SPECIFIED SUBGRADE PER PLANS 1.75" SIEVE: 100% PASSING: NO. 4 SIEVE: CHECK
LIME STABILIZED SUBGRADE - SIEVE ANALYSIS
ASTM D-698 PROCTOR VEDY NEW MATERIAL BOLIDGE 1" - 3" MACHINE POURS; 3" - 5" HAND ASTM C- 143 SLUMP OF PORTLAND CEMEN POURS RST TRUCK EACH DAY + 1 EVERY 150 CY CONCRETE AIR CONTENT BY PRESSURE ASTM C-231 MINIMUM 3% METHOD (FOR FRESH CONCRETE) TEMPERATURE OF FRESHLY MIXED 95 F MAX (HOT WEATHER) AND 50 F MIN STM C- 1084 VERY TRUCK PORTLAND CEMENT CONCRETE (COLD WEATHER) COMPRESSIVE STRENGTH OF CYLINDRICAL 3 CYLCINDERS TAKEN FROM FIRST TRUCK 3,000 PSI MINIMUM FOR TRAFFIC; 4,000 PSI 1 BROKEN AT 7 DAYS AND THE OTHER 2 BROKEN AT 28 DAYS; IF NEEDING TO GET ASTM C.39 ONCRETE SPECIMENS VERY DAY + 3 EVERY 150 CY MINIMUM AT 28 DAYS FFIC ON PAVEMENT FASTER THEN ADDITIONAL CYLINDER BROKEN AT 3 DAYS OBTAINING AND TESTING OF DRILLED ASTM C-42 4.000 PSI COMPRESSIVE AT 28 DAYS 4" DIAMETER TAKEN 28 DAYS AFTER POUR ASTM C-42

OSTAINMEN AND TESTING OF DRAIL

OCNES OF CONCRETE

ASTM C-174

MEASURING LENGTH OF DRILLED

CONCRETE CORES

NOTES: (1) PER LANE, TRENCH, ALLEY OR SIDEWALK ERY 300 LINEAR FEET (1) DEPTH OF PAVEMENT AS SPECIFIED PER

CITY OF MESQUITE, T PUBLIC WORKS DEPA STANDARD DETAILS

TEXAS PARTMENT

MESQUITE

ENERAL DESIGN STAND

Bid Item	Description	Unit							Sheet	Number							BID QTY
			4	5	6	7	8	9	10	11	12	13	14	15	16	17	
1	MOBILIZATION	LS															1
2	TRAFFIC CONTROL IMPLEMENTATION AND MAINTENANCE	LS															1
	REMOVE AND REPLACE 8" THICK, 4000 PSI REINFORCED CONCRETE																
3	PAVEMENT, 12-FT WIDE ALLEY, COMPLETE IN PLACE	SY	830	425	685	285	765	445	685	745	610	280	865	495	790	795	8700
	REMOVE AND REPLACE 6" THICK, 4000 PSI REINFORCED CONCRETE																
	PAVEMENT, DRIVE APPROACH (AS IDENTIFIED BY CITY), COMPLETE IN																
4	PLACE	SY	40	45			65					65		45		40	300
	FURNISH AND INSTALL FLEXIBLE BASE, TxDOT ITEM 247, GRADE 1, TYPE D																
	CRUSHED RECYCLED CONCRETE, INCLUDING EXCAVATION AND																
5	COMPACTION	TON	310	165	260	110	290	170	260	280	230	110	325	190			2700
6	FURNISH AND INSTALL SODDING, COMPLETE IN PLACE	SY	275	140	225	95	255	150	225	250	205	95	290	165	265	265	2900
7	OWNER'S RISK MITIGATION ALLOWANCE	LS															1



EXISTING UTILITIES AND UNDERGROUND FACILITIES INDICATED ON THESE PLANS HAVE BEEN LOCATED FROM REFERENCE INFORMATION. IT SHALL BE THE RESPONSIBILITY OF THE CONTRACTOR TO VERIFY BOTH HORIZONTALLY AND VERTICALLY THE LOCATION OF EXISTING UTILITIES AND UNDERGROUND FACILITIES PRIOR TO CONSTRUCTION, TO TAKE THE NECESSARY PRECAUTIONS IN ORDER TO PROTECT ALL FACILITIES ENCOUNTERED. THE CONTRACTOR SHALL PRESERVE AND PROTECT ALL EXISTING UTILITIES FROM DAMAGE DURING CONSTRUCTION.


STREET REPAIRS FOR ALLEY RECONSTRUCTION CITY CONTRACT # 2024-006


QUANTITY SHEET

SCALE: 1" = 60' DRAWN BY: AK

DATE: 10/10/2023 SHEET: 3 OF 17

REVISIONS

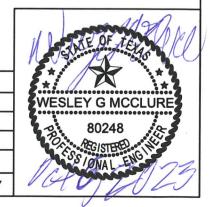

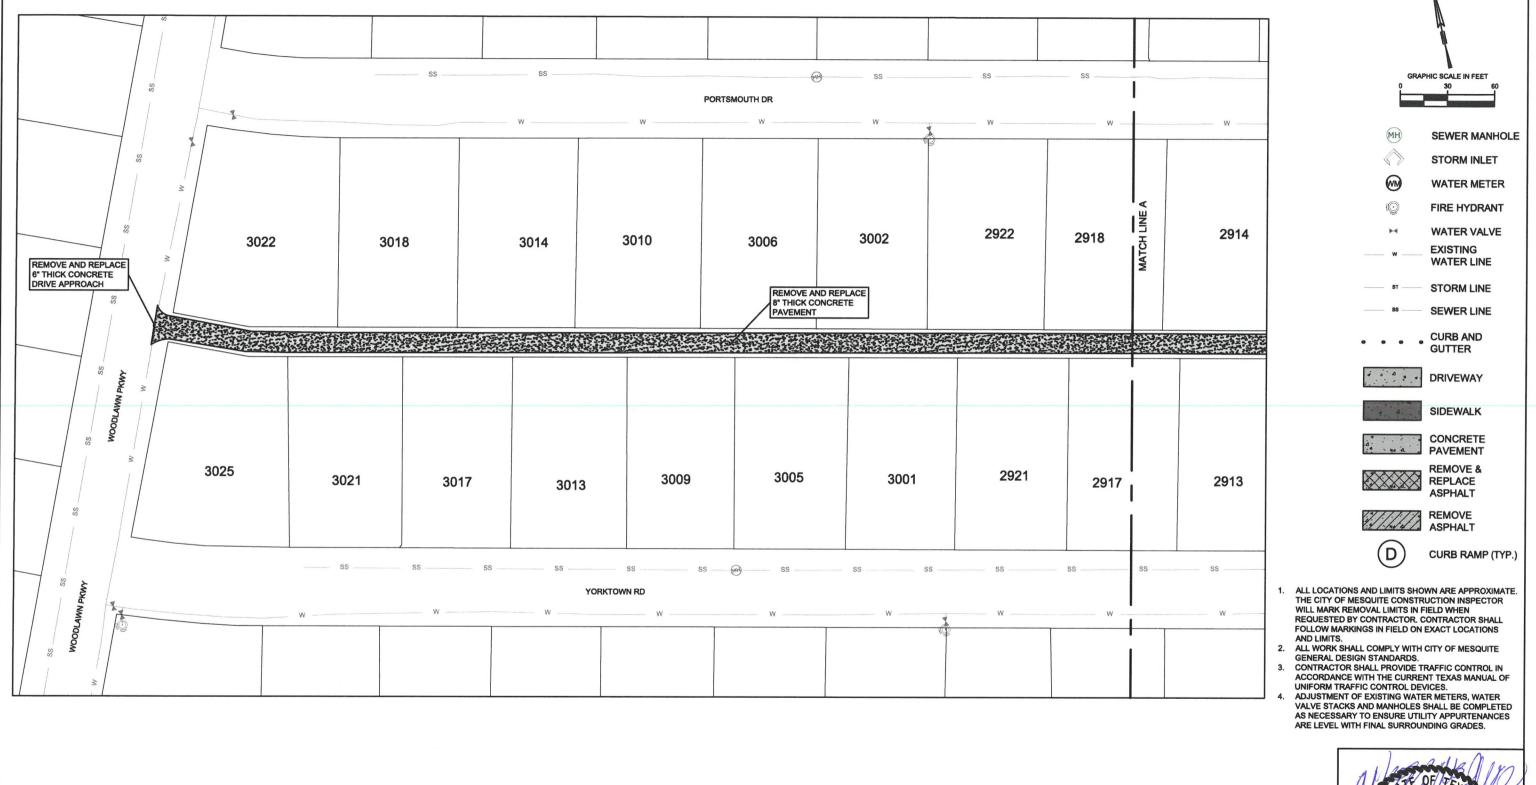



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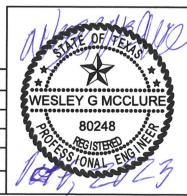
STREET REPAIRS
FOR ALLEY RECONSTRUCTION
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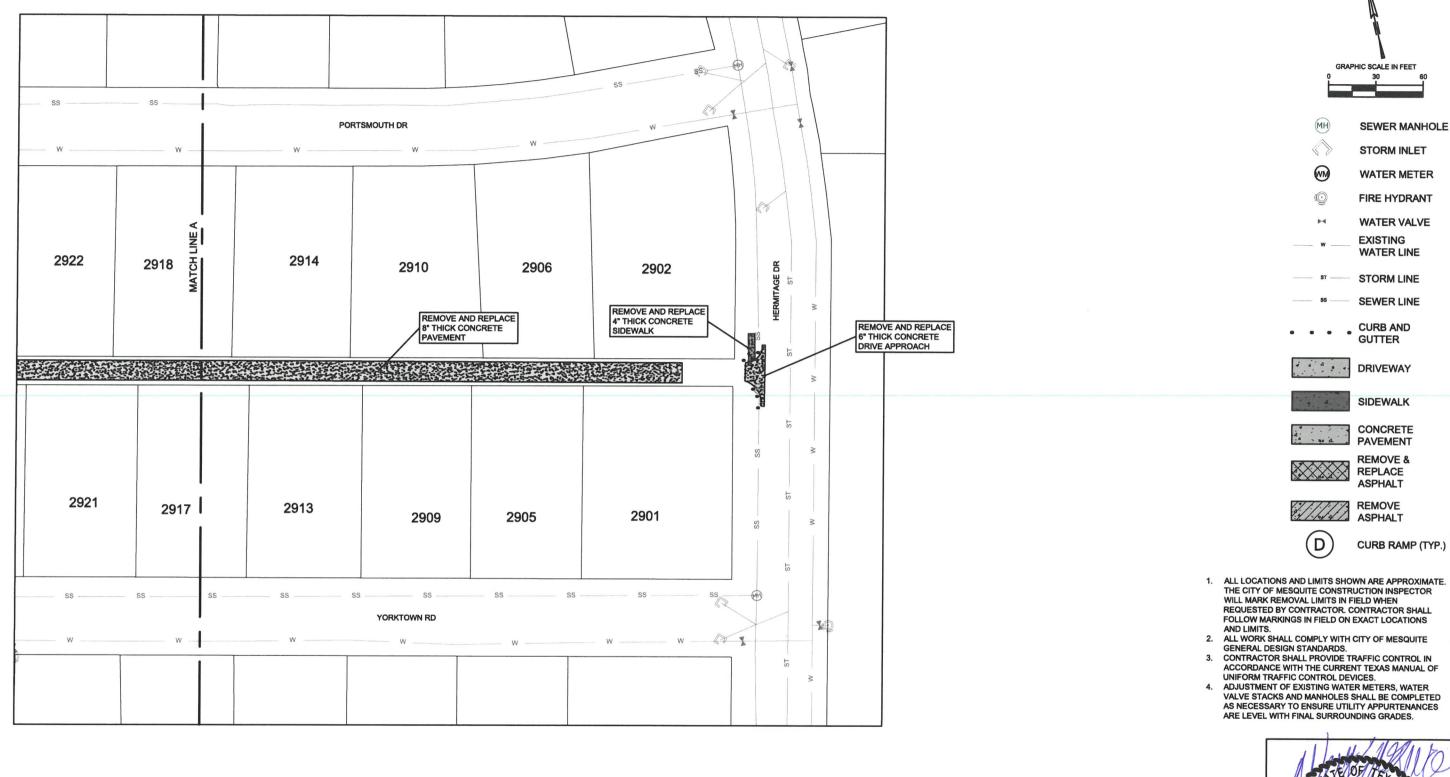
ALLEY RECONSTRUCTION BETWEEN PORTSMOUTH DR AND YORKTOWN RD - 1

REVISIONS

SCALE: 1" = 60' DRAWN BY: AK

DATE: 10/10/2023 SHEET: 4 OF 17







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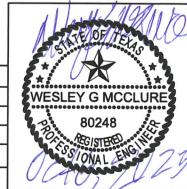
STREET REPAIRS FOR ALLEY RECONSTRUCTION CITY CONTRACT # 2024-006

ALLEY RECONSTRUCTION BETWEEN PORTSMOUTH DR AND YORKTOWN RD - 2


REVISIONS

SCALE: 1" = 60' DRAWN BY: AK

DATE: 10/10/2023 SHEET: 5 OF 17





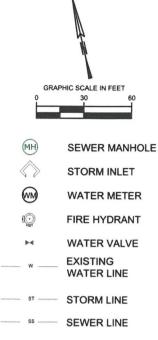

DRIVEWAY

SIDEWALK

CURB AND

GUTTER

CONCRETE PAVEMENT

REMOVE & REPLACE ASPHALT



REMOVE ASPHALT



CURB RAMP (TYP.)

- ALL LOCATIONS AND LIMITS SHOWN ARE APPROXIMATE. THE CITY OF MESQUITE CONSTRUCTION INSPECTOR WILL MARK REMOVAL LIMITS IN FIELD WHEN REQUESTED BY CONTRACTOR. CONTRACTOR SHALL FOLLOW MARKINGS IN FIELD ON EXACT LOCATIONS AND LIMITS.
- AND LIMITS.

 2. ALL WORK SHALL COMPLY WITH CITY OF MESQUITE GENERAL DESIGN STANDARDS.
- CONTRACTOR SHALL PROVIDE TRAFFIC CONTROL IN ACCORDANCE WITH THE CURRENT TEXAS MANUAL OF UNIFORM TRAFFIC CONTROL DEVICES.
- ADJUSTMENT OF EXISTING WATER METERS, WATER VALVE STACKS AND MANHOLES SHALL BE COMPLETED AS NECESSARY TO ENSURE UTILITY APPURTENANCES ARE LEVEL WITH FINAL SURROUNDING GRADES.



Public Works

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STREET REPAIRS FOR ALLEY RECONSTRUCTION CITY CONTRACT # 2024-006

ALLEY RECONSTRUCTION BETWEEN POTOMAC AVE AND FALLS CHURCH LN - 1

REVISIONS


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SHEET: 6 OF 17

DATE: 10/10/2023







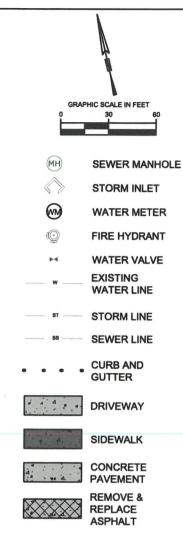

REMOVE ASPHALT



CURB RAMP (TYP.)

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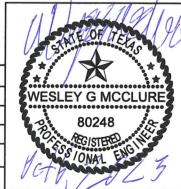
Public Works


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STREET REPAIRS FOR ALLEY RECONSTRUCTION **CITY CONTRACT # 2024-006**

ALLEY RECONSTRUCTION BETWEEN POTOMAC AVE AND FALLS CHURCH LN - 2 **REVISIONS**

SCALE: 1" = 60' DRAWN BY: AK DATE: 10/10/2023 SHEET: 7 OF 17



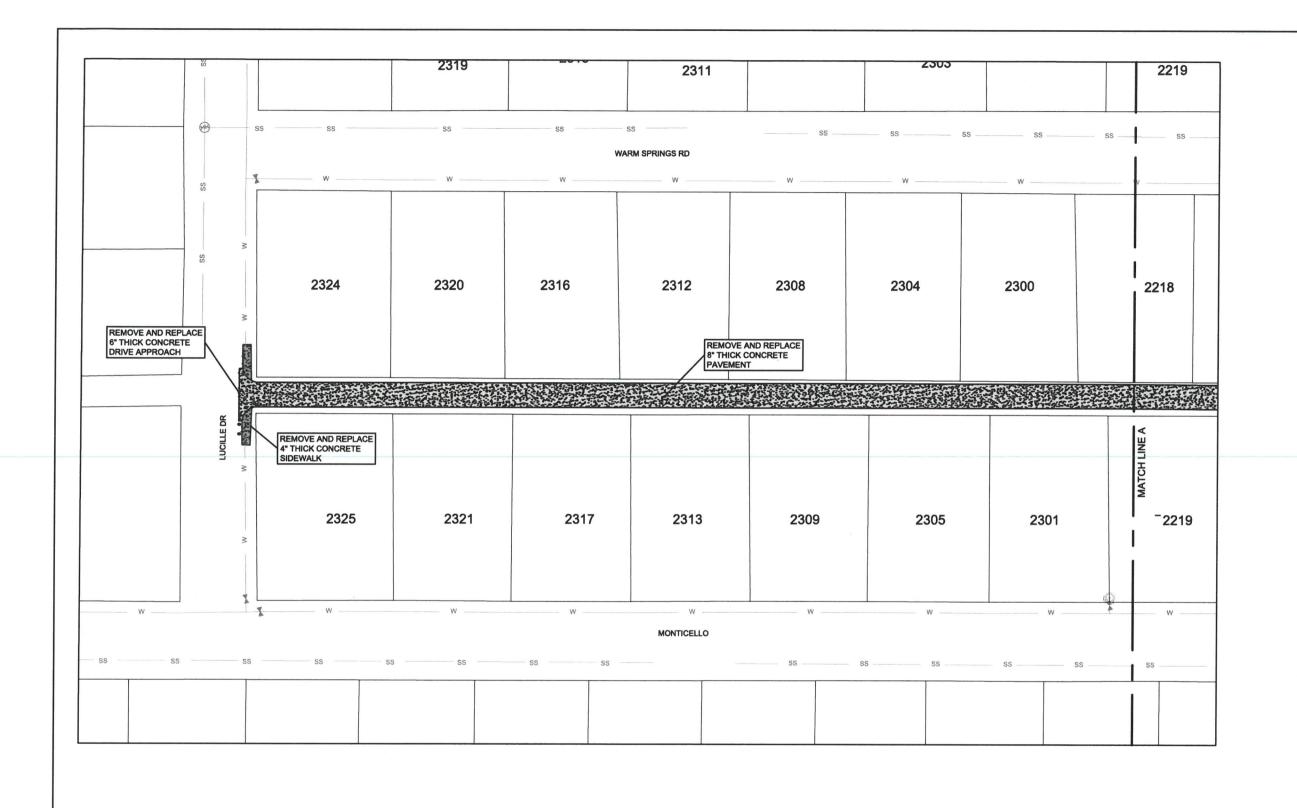

GRAPHIC SCALE IN FEET SEWER MANHOLE STORM INLET WM WATER METER FIRE HYDRANT WATER VALVE **EXISTING** WATER LINE STORM LINE **SEWER LINE CURB AND** GUTTER **DRIVEWAY SIDEWALK** CONCRETE PAVEMENT **REMOVE &** REPLACE **ASPHALT REMOVE ASPHALT**

ALL LOCATIONS AND LIMITS SHOWN ARE APPROXIMATE.
THE CITY OF MESQUITE CONSTRUCTION INSPECTOR
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CURB RAMP (TYP.)

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Public Works

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STREET REPAIRS
FOR ALLEY RECONSTRUCTION
CITY CONTRACT # 2024-006

ALLEY RECONSTRUCTION BETWEEN WARM SPRINGS RD AND MONTICELLO DR - 1

REVISIONS

DRAWN BY: AK


SHEET: 8 OF 17

SCALE: 1" = 60'

DATE: 10/10/2023





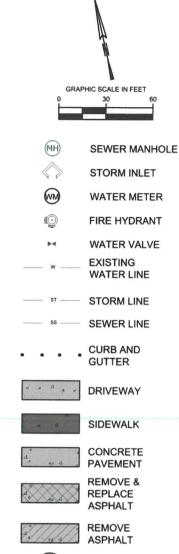

ALL LOCATIONS AND LIMITS SHOWN ARE APPROXIMATE.
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Public Works


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STREET REPAIRS FOR ALLEY RECONSTRUCTION CITY CONTRACT # 2024-006


ALLEY RECONSTRUCTION BETWEEN WARM SPRINGS RD AND MONTICELLO DR - 2

SCALE: 1" = 60' DRAWN BY: AK

DATE: 10/10/2023 SHEET: 9 OF 17



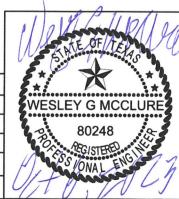

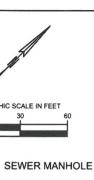

STORM INLET (VM) WATER METER

FIRE HYDRANT

WATER VALVE

EXISTING WATER LINE

STORM LINE

SEWER LINE

CURB AND GUTTER




DRIVEWAY

SIDEWALK



CONCRETE

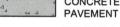









CURB RAMP (TYP.)

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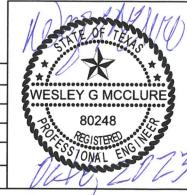
STREET REPAIRS FOR ALLEY RECONSTRUCTION **CITY CONTRACT # 2024-006**


ALLEY RECONSTRUCTION BETWEEN BIG BEND DR AND STROUD LN - 1

REVISIONS SCALE: 1" = 60' DRAWN BY: AK


SHEET: 10 OF 17

DATE: 10/10/2023



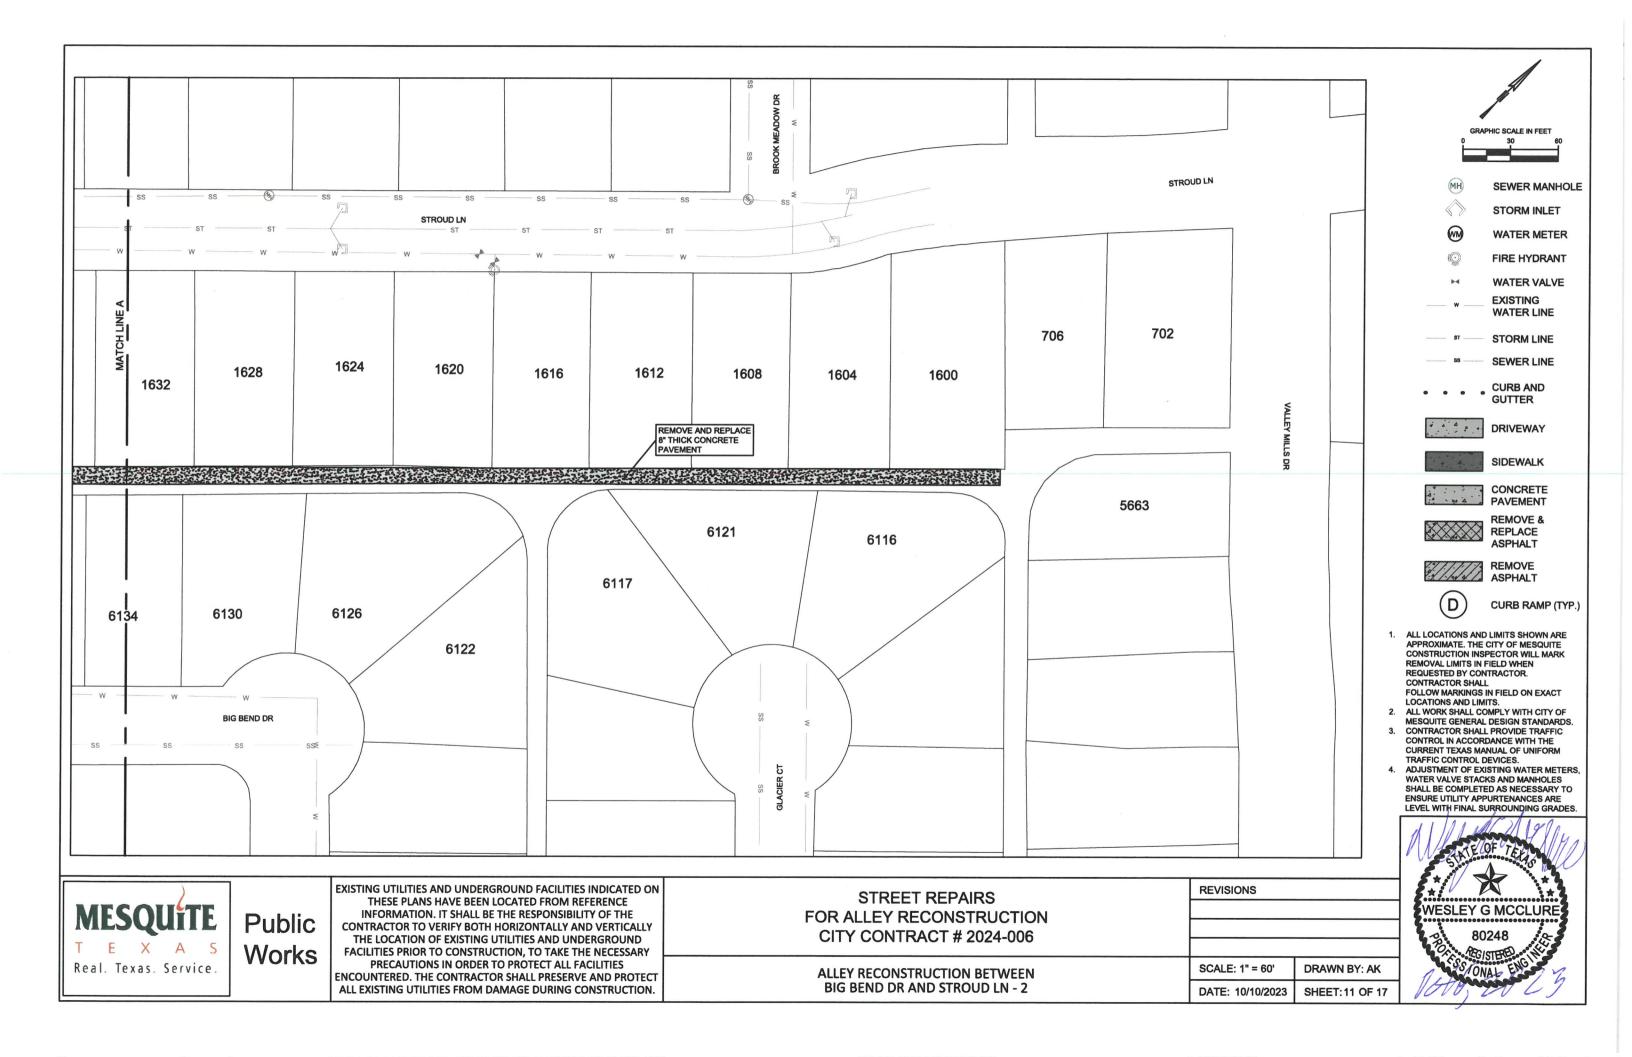



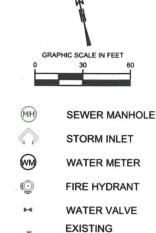

STORM LINE

WATER LINE

SEWER LINE

CURB AND GUTTER

DRIVEWAY

SIDEWALK



CONCRETE **PAVEMENT**

ASPHALT





REMOVE ASPHALT



CURB RAMP (TYP.)

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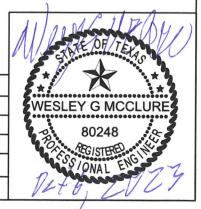



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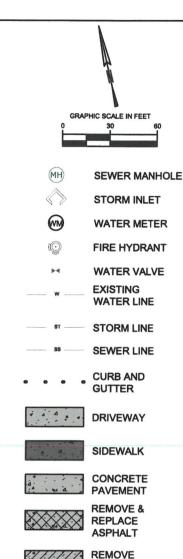
STREET REPAIRS FOR ALLEY RECONSTRUCTION CITY CONTRACT # 2024-006

ALLEY RECONSTRUCTION BETWEEN POTOMAC AVE AND BLUEFIELD RD - 1 **REVISIONS**

SCALE: 1" = 60' DRAWN BY: AK DATE: 10/10/2023 SHEET: 12 OF 17





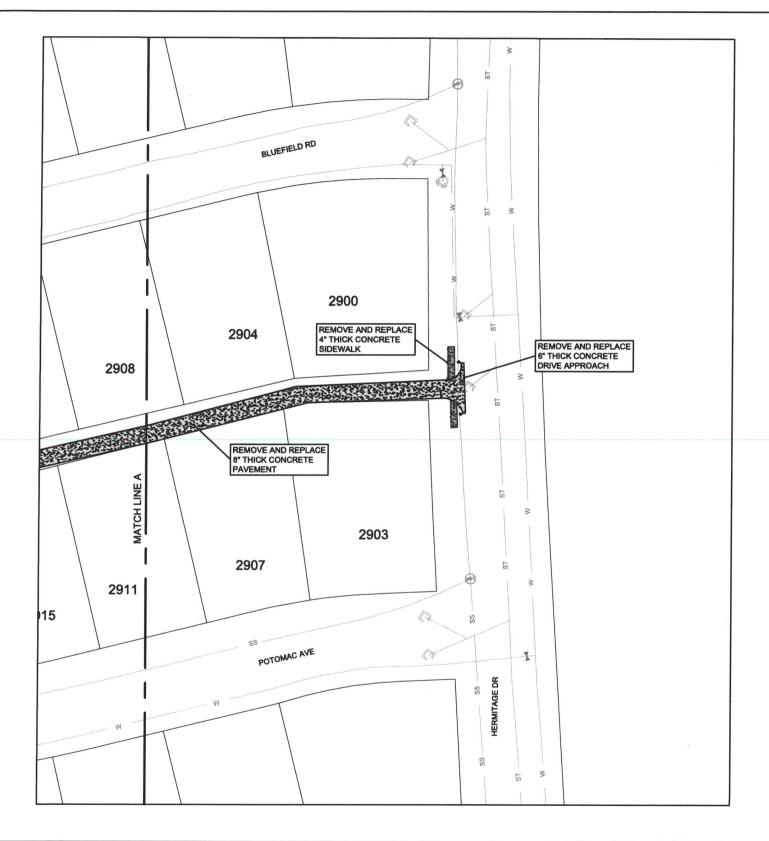



ASPHALT

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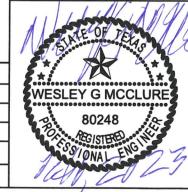


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STREET REPAIRS FOR ALLEY RECONSTRUCTION **CITY CONTRACT # 2024-006**

ALLEY RECONSTRUCTION BETWEEN POTOMAC AVE AND BLUEFIELD RD - 2 **REVISIONS**

SCALE: 1" = 60' DRAWN BY: AK DATE: 10/10/2023 **SHEET: 13 OF 17**







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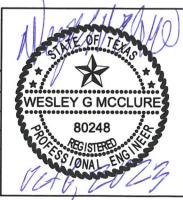
STREET REPAIRS FOR ALLEY RECONSTRUCTION CITY CONTRACT # 2024-006


ALLEY RECONSTRUCTION BETWEEN SKYLINE DR AND YORKTOWN RD - 1

TEVISIONS

SCALE: 1" = 60' DRAWN BY: AK

DATE: 10/10/2023 SHEET: 14 OF 17



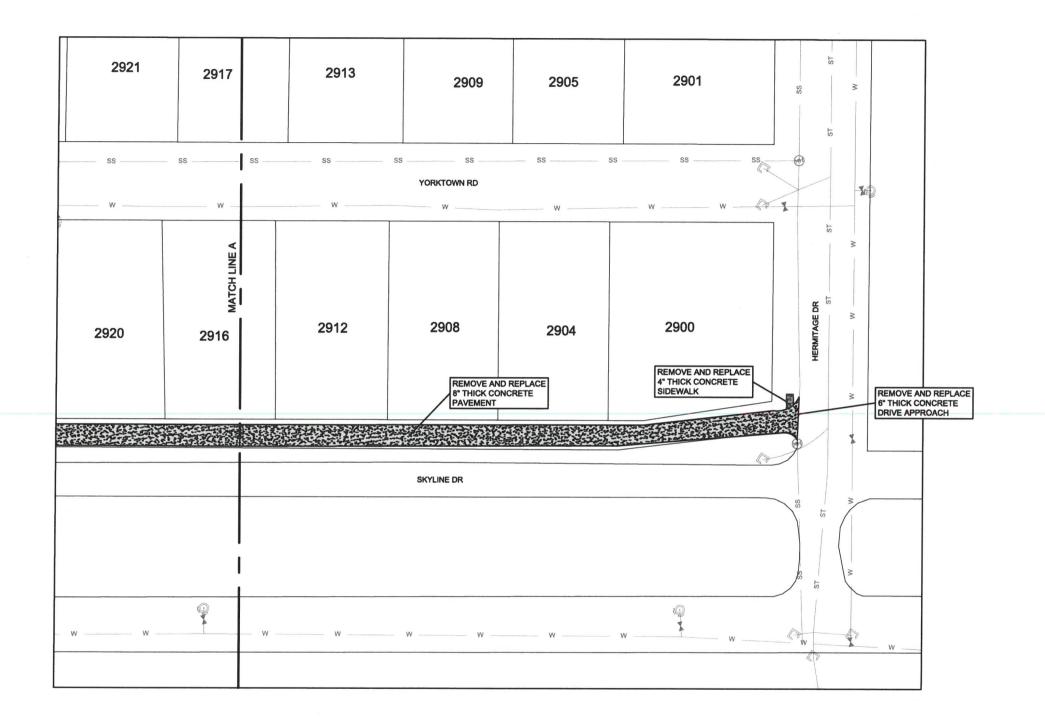



SIDEWALK

CONCRETE **PAVEMENT REMOVE &**

REPLACE **ASPHALT**

REMOVE **ASPHALT**

DRIVEWAY

D

CURB RAMP (TYP.)

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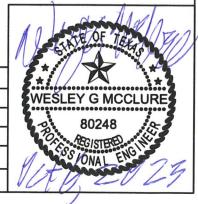
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STREET REPAIRS FOR ALLEY RECONSTRUCTION **CITY CONTRACT # 2024-006**

ALLEY RECONSTRUCTION BETWEEN SKYLINE DR AND YORKTOWN RD - 2 REVISIONS

SCALE: 1" = 60' DRAWN BY: AK

DATE: 10/10/2023 **SHEET: 15 OF 17**








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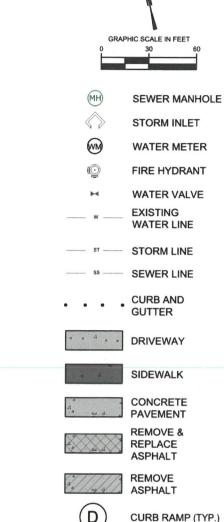
FOR ALLEY RECONSTRUCTION **CITY CONTRACT # 2024-006**

ALLEY RECONSTRUCTION BETWEEN LA PAZ DR AND VIA VENTURA - 1

SCALE: 1" = 60' DRAWN BY: AK **SHEET: 16 OF 17** DATE: 10/10/2023



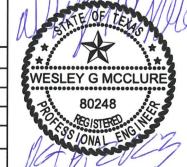



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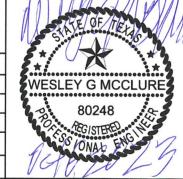
STREET REPAIRS FOR ALLEY RECONSTRUCTION CITY CONTRACT # 2024-006


ALLEY RECONSTRUCTION BETWEEN
LA PAZ DR AND VIA VENTURA - 2

REVISIONS

SCALE: 1" = 60' DRAWN BY: AK

DATE: 10/10/2023 SHEET: 17 OF 17



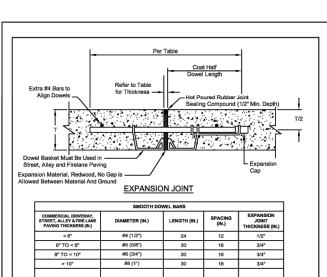

SIDEWALK, RESIDENTIAL DRIVEWAY AND TRAIL THICKNESS (IN.)

LENGTH (IN.)

- ISS.

 EXPANSION CAP FOR DOWELS SHALL HAVE AN INSIDE DIAMETER OF 1/16" GREATER THAN THAT OF THE DOWEL AND BE DESIGNED TO PROVIDE FIRE MOVEMENT OF THE DOWEL BAR.


 EXPANSION CAP TO FIT DOWEL MIN. 2" EMBEDMENT AND MIN. 1-10" CLEARANCE FROM THE CLOSED END OF THE SLEEVE TO THE DOWEL.


 EXPANSION JOINTS SHALL BE INSTALLED AT A MAXIMUM DISTANCE OF 600 FEET, AND AT STREET INTERSECTIONS RADII, PCS AND PTS OR AS OTHERWISE DIRECTED. NO EXPANSION JOINT SHALL FALL IN A DRIVEWAY APPROACH OR INLET. EXPANSION METRILA SHALL BE REDVIOCO MATERIAL UNLESS OTHERWISE APPROVED DOWEL BARS TO BE PLACED PARALLEL TO PAVEMENT AT SPACING AND LENGTHS FRET TABLE, CENTERED ON EXPANSION MATERIAL. ONE SIDE OF DOWEL BARS AND SHALL FALL OF THE THE THE APPROVED DE-BONDING MATERIAL. WHERE DISLING OF DOWEL BARS IS REQUIRED, IT SHALL ER LONG BY AN APPROVED MECHANICAL RIG. EXPANSION JOINTS SHALL NOT BE FLACED AT PROMEENT OF SHEEPEN.

DIAMETER (IN.)

#4 (1/2")

MESQUITE	Public	EXPANSION JOINTS	GENERAL DESI	
T E X A S Beal, Texas, Service,	Works	EXPANSION JOINTS	SCALE: N.T.S REVISION DATE: 05/17/2022	SHEET: P-1

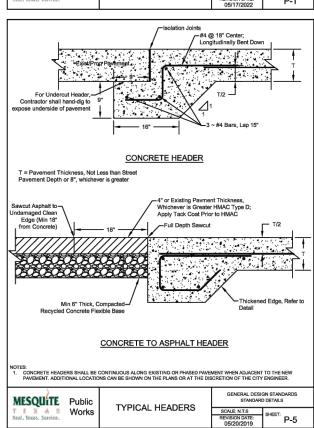

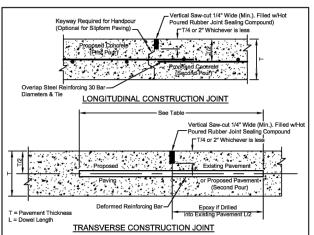

DEFORMED REINFORCING BARS						
COMMERCIAL DRIVEWAY, STREET, ALLEY & FIRE LANE PAVING THICKNESS (IN.)	DIAMETER (IN.)	LENGTH (IN.)	SPACING (IN.)			
< 6"	#4 (1/2")	24	12			
6" TO < 8"	#5 (5/8")	30	18			
8" TO < 10"	#6 (3/4")	30	18			
> 10"	#8 (1")	30	18			
SIDEWALK, RESIDENTIAL DRIVEWAY AND TRAIL THICKNESS (IN.)	DIAMETER (IN.)	LENGTH (IN.)	SPACING (IN.)			
4" TO 6"	#4 (1/2")	24	12			

- ES:
 DOWEL BARS TO BE PLACED PARALLEL TO PAVEMENT AT SPACING AND LENGTHS PER TABLE. WHERE DRILLING OF DOWEL
 BARS IS REQUIRED, IT SHALL BE DONE BY AN APPROVED MECHANICAL RIG.
 TRANSVERBES CONSTRUCTION JOINT CAN BE USED AS LONGITUDINAL CONSTRUCTION JOINT IN APPLICATIONS WHERE NEW
 PAVEMENT IS TO BE CONSTRUCTED OR RECONSTRUCTED NEXT TO CLD PAVEMENT.

 IF DOWELING INTO EXISTING PAVEMENT THAIT IS OF ALL BSIS IN THORNESS, USE TRANSVERSE CONSTRUCTION JOINT DETAIL.

MESQUITE	Public	CONSTRUCTION JOINTS	GENERAL DESII STANDARI	
T E X A S Beal, Texas, Service,	Works	CONSTRUCTION JOINTS	SCALE: N.T.S REVISION DATE: 05/17/2022	SHEET: P-2

Pavement Reinforcement-

-Bent #4 at 18" OC

SCALE: N.T.S

REVISION DATE: 05/20/2019


SHEET: P-6

#4 Bar, Typ. ¬


MESQUITE Public THICKENED CONCRETE

EDGE

Works

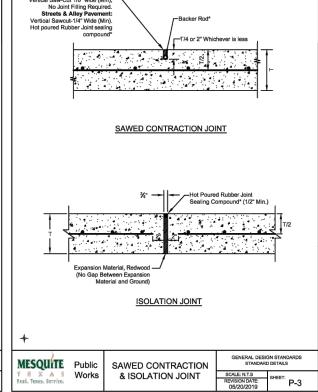

Sidewalk & Trails: Vertical Saw-Cut 1/8" wide (Min),

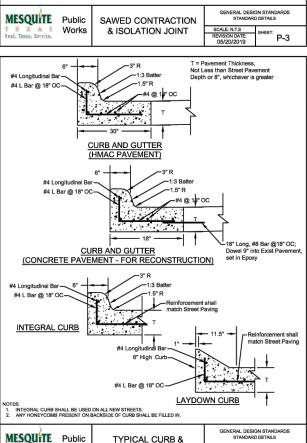


GUTTER

Works

SCALE: N.T.S


REVISION DATE: 07/22/2019

P-7

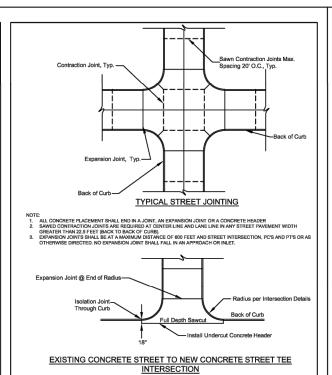



PAVING

CITY OF MESQUITE, TEXAS PUBLIC WORKS DEPARTMENT STANDARD DETAILS

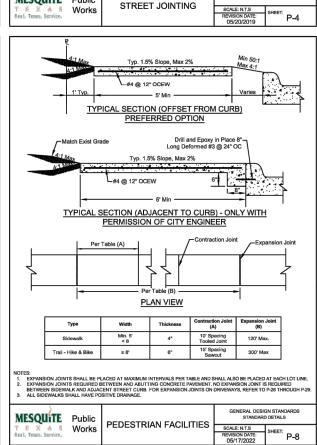

MESQUITE Public

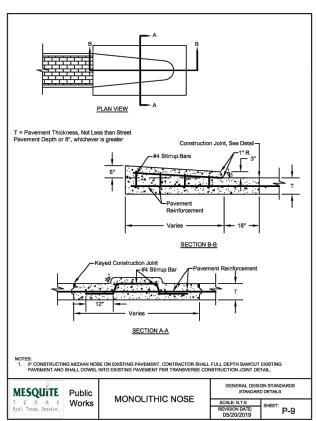


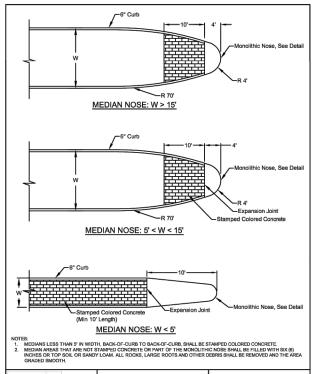



MEDIAN


MESQUITE Public


Works

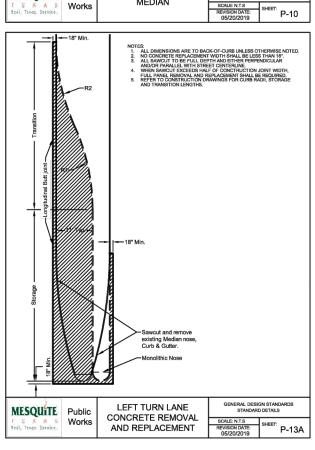

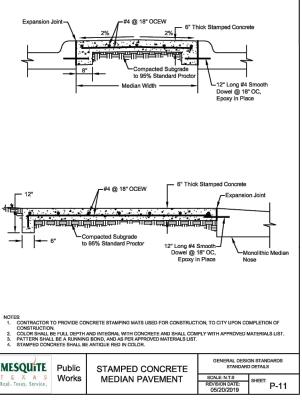


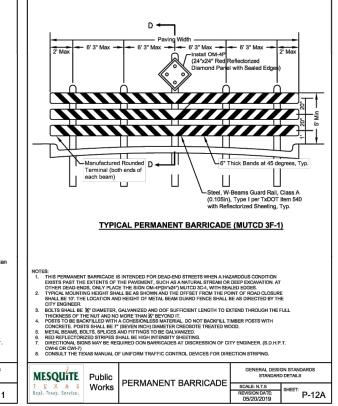

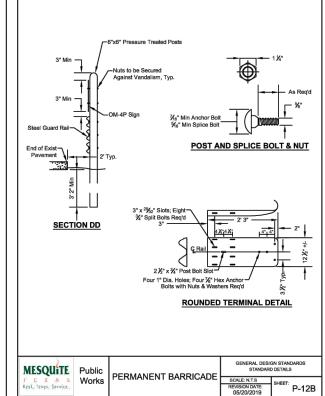

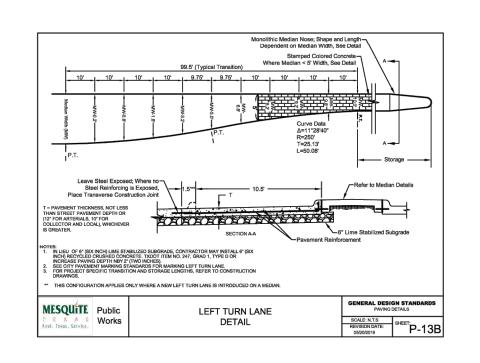


CITY OF MESQUITE, TEXAS PUBLIC WORKS DEPARTMENT STANDARD DETAILS

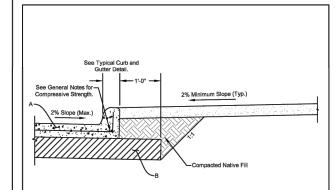

Classification	Minimum Pavement Thickness (A)	Minimum Subgrade Thickness (B)	Minimum Bar: Maximum Spacing Reinforcing Steel		
Local	6"	6" Lime Stabilized at 8% (Or 6" Crushed Concrete)	#4 @ 18" C.C.		
Collector	8"	8" Lime Stabilized at 8% (Or 8" Crushed Concrete)	#4 @ 18" C.C.		
Fire Lane		Per Fire Lane Detail			
Alleys	Per Typical Alley Detail				
Arterials	Per Engineering Design Manual Section 2.11 #4 @ 18" C.C.				

RUTE: CRUSHED CONCRETE SHALL MEET TXDOT SPECIFICATIONS, ITEM 247, TYPE D, GRADE 1 OR 2 WITH TRIAX TX 140 GEOGRID (OR APPROVED EQUAL.

MESQUITE	Public	CONCRETE PAVEMENT	GENERAL DESI STANDARI	
T E X A B Bent, Texas, Senvice,	Works	TYPICAL SECTION	SCALE: N.T.S REVISION DATE: 05/20/2019	SHEET: P-14

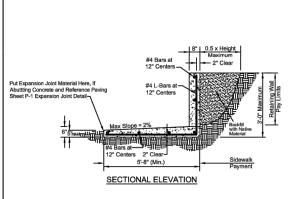

- NOTES:

 1. EXPOSED FACE OR WALL SHALL HAVE FORM LINER SIKA GREENSTREAK M/S9, SIERRA DRYSTACK OR SYMONS S/S170075, 8317080S STANDARD DRY STACK OR AS DIRECTED BY THE CITY ENGINEER, FORM LINER IS REQUIRED FOR WALL OF (DX MCHES) IN HEIGHT AND OVER.

 WALL OF (DX MCHES) IN HEIGHT AND OVER.

 CHEMIT CONTENT.

 3. MINIMUM GRADE OF REINFORDING STEEL IS TO BE ASTIM A/51, GRADE 69.


 ALL DISTANCES TO REINFORDING STEEL IS TO BE ASTIM A/51, GRADE 69.

 ALL DISTANCES TO REINFORDING STEEL IS TO BE THIRTY (69) BARD DIMETERS.

 5. MINIMUM SPACING OF EXPRONEING STEEL REFER TO CLEAR CONCRETE COVER OVER REINFORCING STEEL LINLESS TO BE THIRTY (69) BARD DIMETERS.

 5. MINIMUM SPACING OF EXPRANSION JOINTS SHALL BE 120- FEET. AN EXPANSION JOINT SHALL BE 120- FEET. AND EXPANSION JOINT SHALL BE 120- FEE

MESQUITE	Public	CONCRETE SIDEWALK	GENERAL DESIG STANDARI	
T B X A B Beal, Texas, Service.	Works WITH RETAINING WALL	WITH RETAINING WALL	SCALE: N.T.S REVISION DATE: 05/20/2019	SHEET: P-15

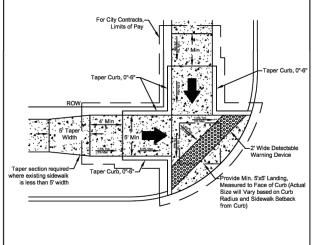

TIES:


ALL PEDESTRIAN ELEMENTS, INCLUDING CURB RAMPS, SHALL COMPLY WITH THE PROPOSED ACCESSIBILITY
GUIDELINES FOR PEDESTRIAN FACILITIES IN THE PUBLIC REGHT-OF-WAY (PROVING), PUBLISHED BY THE
HEADOFTED GUIDELINES.

BETTAL ADOFTED GUIDELINES.

ALL PEDESTRIAN PATHS SHALL HAVE TYPICAL 1-5% (PERCENT), MAXIMUM 2% (PERCENT) CROSS SLOPE.

DETAILS ARE REPRESENTATION OF INFORMATION FROM PROMPAGO AND ARE INTENDED TO PROVIDE GUIDANCE. IT IS
THE RESPONSIBILITY OF THE DESIGN PROFESSIONAL AND THE CONTRACTOR TO ENSURE THAT ALL RAMPS
CONSTRUCTED MEET THE REQUIREMENTS OF PHOMAG.

MESQUITE	Public	CURB RAMP	GENERAL DESIG	
TEXAB	Works	TYPE A	SCALE: N.T.S	SHEET:
Real, Texas, Service,		OIRS TIPEA	REVISION DATE: 09/08/2020	P-16

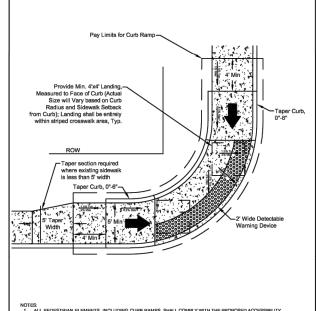


NOTES:

1. ALL PEDESTRIAN ELEMENTS, INCLUDING CURB RAMPS, SHALL COMPLY WITH THE PROPOSED ACCESSIBILITY GUIDELINES FOR PEDESTRIAN FACILITIES IN THE PUBLIC RIGHT-OF-WAY PROWING, PUBLISHED BY THE ARCHITECTURAL AND TRANSPORTATION COMPLIANCE BACKDO DULLY (1), 20.11, 36 CPT RATE 1180 OR ITS FINAL ADOPTED GUIDELINES.

ADOPTED GUIDELINES.

5. DETAILS ARE REPRESENTATION OF INFORMATION FROM PROWING AND ARE INTENDED TO PROVIDE GUIDANCE. IT IS THE RESPONSIBILITY OF THE DESIGN PROPOSESOMA. AND THE CONTRACTOR TO ENSURE THAT ALL RAMPS CONSTRUCTED MEET THE REQUIREMENTS OF PROWING.

MESQUITE	Public	CURB RAMP	GENERAL DESIGNATION OF THE STANDARD	
TEXAS	Works	TYPE B	SCALE: N.T.S	SHEET:
Real, Texas, Service,			REVISION DATE: 09/08/2020	P-17

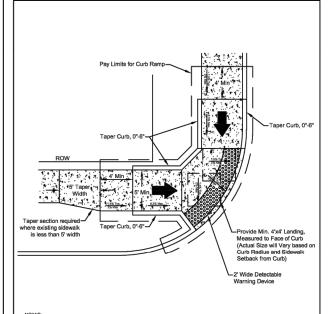


- NOTES:

 1. ALL PEDESTRIAN ELEMENTS, INCLUDING CURB RAMPS, SHALL COMPLY WITH THE PROPOSED ACCESSIBILITY GUIDELINES FOR PEDESTRIAN FACILITIES IN THE PUBLIC RICHT-OF-WAY (PROWAG), PUBLISHED BY THE ARCHITECTURAL AND TRANSPORTATION COMPLIANCE BACRD ON JULY 18, 2011, 38 CFR PART 1180 OR ITS FINAL ADOPTED GUIDELINES.

 2. ALL PEDESTRIAN PRINSPART AND THE PROPARTION FOR THE PROPAGORY OF THE PROPAGORY OF


MESQUITE	Public	CURB RAMP	GENERAL DESI	
T E X A S Beal, Texas, Service,	Works	TYPE C	SCALE: N.T.S REVISION DATE: 09/08/2020	P-18

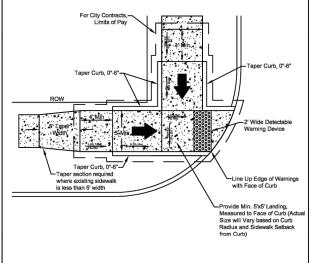

- NOTES:

 1. ALL PEDESTRIAN ELEMENTS, INCLUDING CURB RAMPS, SHALL COMPLY WITH THE PROPOSED ACCESSIBILITY GUIDELINES FOR PEDESTRIAN FACILITIES IN THE PUBLIC RIGHT-OF-WAY (PROWAS), PUBLISHED BY THE ARCH TECTURAL AND TRANSPORTATION COMPLIANCE BAORD ON JULY 16, 2011, 36 CFR PART 1190 OR ITS FINAL ADOPTED GUIDELINES.
- IDELINES. BIAN PATHS SHALL HAVE TYPICAL 1.5% (PERCENT), MAXIMUM 2% (PERCENT) CROSS SLOPE. BERDECENTATION OF INFORMATION FROM PROMAG AND ARE INTENDED TO PROVIDE GUID

			DESIGN PROFESSIONAL AND THE CONTRACTOR T EQUIREMENTS OF PROWAG.	TO ENSURE THAT ALL F	RAMPS
	MESQUITE	Public	CURB RAMP	GENERAL DESIGNATION OF THE STANDARD	
1	T E X A S	Works	TYPE D	SCALE: N.T.S	SHEET:
	Beell, Texas, Service,		11125	REVISION DATE: 09/08/2020	P-19

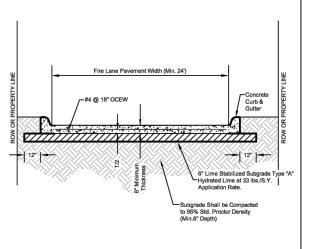

NOTES:

1. REFER TO DETAIL FOR EXPANSION JOINT AND CONTRACTION JOINT, FOR SPACING, ETC, OF JOINTS.

2. WHERE A CURB IS USED, THE REQUIRED CLEARANCE SHALL BE MEASURED FROM THE CURB FACE TO ANY PERMANENT TRAFFIC OBSTACLE.

3. PERMANENT TRAFFIC OBSTACLE.

4. OF GISK INCH, LIME STABILIZED SUBGRADE MAY BE SUBSTITUTED BY ETHER ADDITIONAL? (TWO INCHES) OF CONCRETE PAVING OR (FIX INCHES) ETC.

5. OF GISK INCH, LIME STABILIZED SUBGRADE MAY BE SUBSTITUTED BY ETHER ADDITIONAL? (TWO INCHES) OF CONCRETE PAVING OR (FIX INCHES) REVOLUTED CONCRETE FOAUTE OR OR AJT, TYPE 1, GRADE D).

5. ALL DIMINISIONS ARE FACE TO FACE OF CURB. WHERE A FIRE LAND EDAD BINDS AND EXCEEDS 150 (FEET) LENGTH, A HAMMERNEAD OR OLL-OF-SAC PER DETAIL P14-8 MUST BE PROVIDED FOR THE FIRE TRICKT TO TURN AROUND.

6. FOR FIRE LIME PAVING HOW THINDS, REFER TO SOSI IN ITERNATIONAL FIRE COSE APPRIXED TO 15 WAY OUT OF ORDINANCES.


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 FOR FIRE LINE PAVEMENT WIDTH, REPER TO 2015 INTERNATIONAL FIRE CODE APPENDIX D 103 AND CITY ORDINANCES 4486 AND 4499 FOR AMENDMENTS. 									
MESQUITE Pu	ıblic	FIRE LANE	GENERAL DESIGN STANDARDS STANDARD DETAILS						

SCALE: N.T.S REVISION DATE: 05/20/2019

SHEET:
P-20



LETTERING SHALL BE "FIRE LANE - NO PARKING" OR "NO PARKING - FIRE LANE" WITH 4" (FOUR INCH) WHITE LETTERS
 WHERE CURB IS AVAILABLE, THE STRIPING SHALL BE ON THE VERTICAL FACE OF CURB.

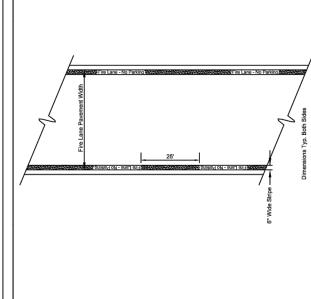FIRE LANE

STRIPING

MESQUITE Public

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Real, Texes, Service,

GENERAL DESIGN STANDARDS STANDARD DETAILS


SCALE: N.T.S


REVISION DATE: 05/20/2019

SHEET: P-21

CITY OF MESQUITE, TEXAS PUBLIC WORKS DEPARTMENT STANDARD DETAILS

PAVING-

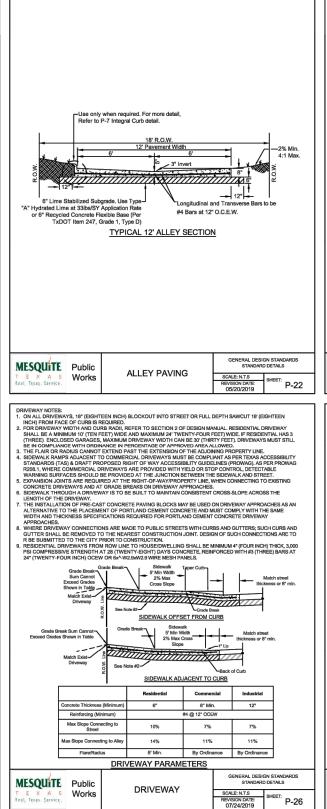


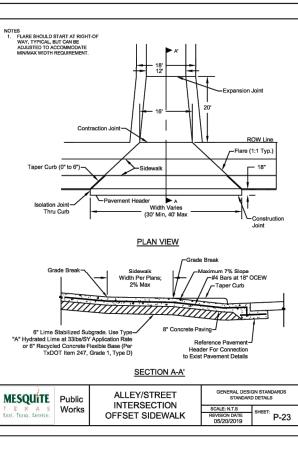



ROW or Property Line-


MESQUITE Public


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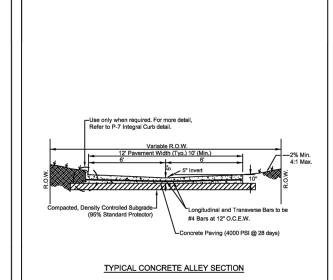


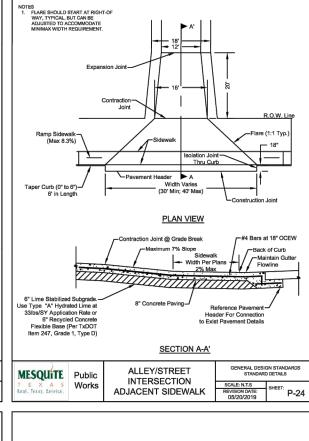CITY OF MESQUITE, TEXAS PUBLIC WORKS DEPARTMENT STANDARD DETAILS

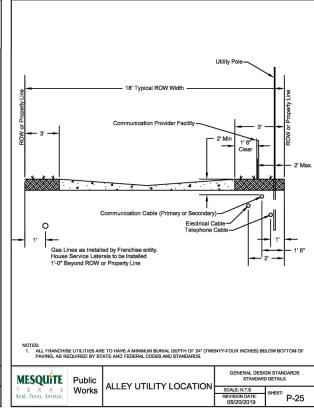MESQUITE
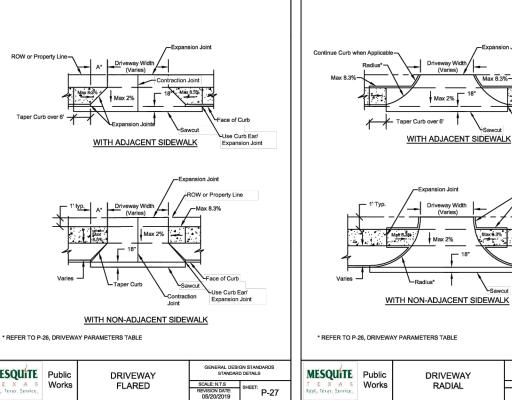
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Alley Replacement Design and Construction Guidelines and Requirements

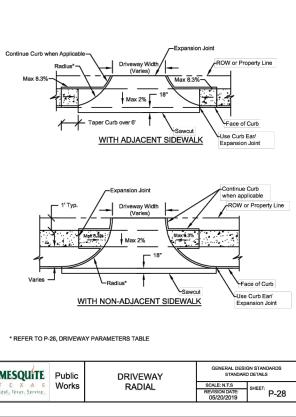Alley Pavement Section in the available ROW:
Design and construction objective is to build the reconstructed alley as close as possible to the standard 12-foot wide aving section within the available ROW.

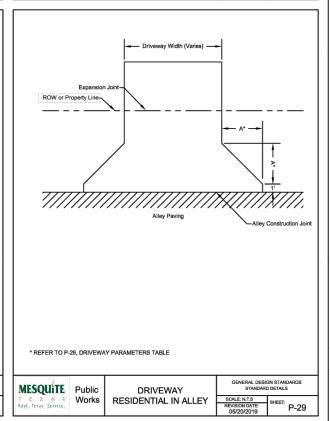- Generally the following apply to reconstructed alloy widths:

 10-foot wide alley paving width (clear driving area not including curbs or walls) is a minimum.

 15-foot wide ROW 10-foot minimum alley paving width with alley parkway of 2.5-feet is 10' typical section.

 18-foot or larger ROW width 12-foot alley paving width with alley parkway of 3.0-feet is 12.' typical

In instances where the existing alley ROW width is less than the current 18-foot wide standard but the alley abuts vacant property or property with a large landscaped buffer adjacent to the alley, the 12-foot desirable width can be achieved by simply off-setting the alley paving in the ROW and pushing the paving section toward the vacant property to obtain the 12-foot paving section and a 3-foot grassed alley parkway on the developed side of the property. This may result in the alley paving edge directly on the ROW line on the side of the alley naxt of the alley paving edge directly on the ROW line on the side of the alley naxt to the vacant tract or large landscape buffer. This is acceptable as additional ROW for the alley (to bring it up to the current 18-foot dard) can be required upon development/platting of the vacant tract.

The minimum standard paying section for reconstruction alleys is a 10"-5"-10" section reinforced with #4 bars at

his minimum paving section can be made thicker and/or additional reinforcing steel added if con rarrant (such as tractor-trailer trucks frequently using the alley for deliveries).

Alley Inverts:

• Alleys on reconstruction projects are usually in older neighborhoods with no drainage systems or drainage systems that are severely undersized by current standards. Deeper inverts will improve alley drainage ca and also force any future birdbaths to the center of the alley thereby reducing their size.


- Alley inverts for reconstruction projects shall be a minimum of 5-inches deep.
- The 5-inch deep minimum invert depth for reconstructed alleys shall not be decreased without express permission by the City Engineer.

Drainage Considerations and Setting of Grades:

1. Pull the record drawings (plan and profile, and if available drainage area maps and lot grading plans) for the alley being worked upon in order to determine the alley being worked upon in order to determine the alley grades that were originally constructed and the general drainage patterns. In many cases these grades will still work for the reconstruction. The engineering plans shall list all these record drawings in a table on the relevant plan sheet for each alley.

Review the record drawings for the **lot grading plans or drainage area maps** for the adjacent subdivisions and developed areas to note drainage patterns that must be maintained with the new alley grades. Many older subdivisions will not have lot grading plans but will have drainage area maps. List and review all relevant record drawings that are available in a table on the plan sheet.

MESQUITE	Public	ALLEY REPLACEMENT	GENERAL DESIGN STANDARDS STANDARD DETAILS	
TEXAS	Works	GENERAL NOTES	SCALE: N.T.S	SHEET:
Real, Texas, Service,		SEIVEI VIE NOTES	REVISION DATE: 8/5/2020	P-22C

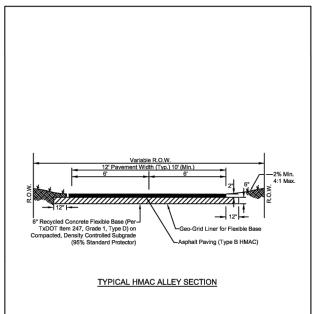

MESQUITE T E X A B Beal. Texas. Service.	Public Works	ASPHALT ALLEY REPLACEMENT	GENERAL DESIGN STANDARDS STANDARD DETAILS	
			SCALE: N.T.S REVISION DATE: 08/05/2020	P-22B

- Try to maintain the preferred minimum grade of 1.0% to avoid birdbaths and ponding that occur on the expansive clay soils that are prevaient in Mesquite.

 Preferred minimum Grade: 1.0%

 Absolute minimum Grade: 0.5%


 Please allet the City Public Works Construction Inspector if these grades cannot be met and ask for guidance.

- . If obtaining enough fall to maintain minimum grades is difficult, changing the downstream alley approach grades can often generate close to another 6-inches of fall by lowering the alley invert grades to within 2-inches with the downstream street gutter. If the approach includes a sidewalk, the existing sidewalk can be sloped a maximum
- 5. It is imperative that the new alley grades do not block drainage from the backyards of homes or other property adjacent to the alley. The contractor shall first expose the bottom of the existing fences the entire length of the alley to be reconstructed. Generally setting the top of the alley paving edge a couple of inches belothe bottom of the fences at each property line is a good method of setting initial grade for the new alley.
- The edge of the new alley paving shall be low enough so that all small drain outlets (from area drains and French drains) drain into the alley. While exposing the bottom of the fences it is important to keep an eye out for these small drain outlets so they are not overlooked. These drain outlets are often of small diameter (2' to 4' is common) and are partially or totally buried.
- The edge of the new alley paving shall be low enough so that all outwardly opening gates can still open and operate without striking the new alley pavement.
- b. The contractor shall plot the proposed grades on graph paper and a string line set for the edge of alley pavement on each side of the alley. The edge of paving grades shall be the same for both sides of the alley. The City Supervisor/ Crew Chief shall check the plot for minimum grades; and shall also check the contractor set string line to ensure it meets the above oriteria; it is critical that the Supervisor/ Crew Chief check the string line on the low side of the alley. Once the Supervisor/ Crew Chief approves the string line grades he shall initial the contractor's plot and retain a copy of this plot for the City files. The Supervisor/ Crew Chief shall also document the stringline grades by placing string line elevation reference marks on objects along the alley and also shall take photograph of the approved stringline. The Supervisor/ Crew Chief shall also inspect form grades before pouring concrete to

Alley Intersection Radii:
Older alleys generally have very short turn and intersection radii that make it difficult for trash trucks to negoliate the turns without damaging fences or running off of the pavement. Radii at alley intersections and turns should be pushed as far as practical toward the properly lines (especially the inside radii) without regard to maintaining a grassed parkway area in order to minimize trash trucks rutting at these intersections; 6-inches off existing fences works well in most cases.

At times enlarging the radii and approaches may require the movement of power poles, or pedestals at these

MESQUITE	Public	ALLEY REPLACEMENT	GENERAL DESIGN STANDARDS STANDARD DETAILS	
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MESQUITE TEXAS Lead. Texas. Service.	Public Works	ALLEY/STREET INTERSECTION OFFSET SIDEWALK	GENERAL DESIGN STANDARDS STANDARD DETAILS	
			SCALE: N.T.S REVISION DATE: 05/20/2019	SHEET: P-23

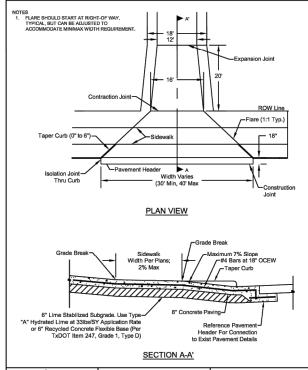Alley Approaches:
Alleys shall connect to City streets via a flared driveway apron (reference City Standard Detail for Alley Approaches)
Generally upstream alley approaches shall have no inverts and rise 6-inches from the street gutter grade to prevent
street drainage from entering the new alley.

Alley Appurtenances:
The design consultant shall show all private improvements that will be impacted by the proposed construction including garages, sheds or other structures, stairs, fences, screening or retaining walls, driveways, parking lots, walkways, drains or drain outlets, or other appurtenances on the construction plans. The contractor shall pour trash pads and other incidental paving adjacent to the alley level with the edge of the alley pavement to avoid building an object that could damage a tire or tire rim.

Franchise Utility Coordination: Call 811 for locates at least 48 hours prior to construction.

- Asphalt Alley Reconstruction Procedure:

 Provide 2* HMAC, type B at 10* wide on 6* thick recycled concrete base.

 Subgrade preparation per NCTCOG standards section 301.3.3.1. (Compacted with HD Sheepsfoot roller; 95% Standard Protector within optimum moisture (0 to +6%)).

 Geo-grid (Triax) per TxDOT Item 356 and Material List, Tensar TriAx 120 (or approved equal) in 12* wide rolls.

 Base Material per TxDOT Item 247, Grade 1, Type D.

 2- inches Hot Mix Asphalt Concrete (Type B HMAC) per NCTCOG standards section 302.9.

- Sequence of Construction:

 Schedule selected alleys by area ensuring that all funds are spent in different parts of the city.

 State alley construction and closure notices.

 Schedule full utility line is coates.

 Locate existing city utility lines such as sanitary sewer manholes and clean outs.

 Pothole and locate possible conflicts with franchised utilities, such as gas, electric and phone lines.

 Install work zone traffic notnotion signs and barriacates for alley and staging area.

 Clear right of way for trees, vegetation, structures and debris.

 Excavation and removal of existing deteriorated concrete pavement, patches, etc. materials.

 Excavation to depth and width for new base and paving materials.

- Expose the bottom of adjacent fences.
- Expose the bottom of adjacent fences.
 Subgrade preparation hydration and compaction.
 Base material placing hydration and compaction.
 Utility adjustments: raising manholes, inlet throats, etc.
 R.O.W. grading and clearing.
 Issue alley reopening notices.
 Remove work zone traffic control and place the alley back in service.


- MESQUITE Public

ALLEY REPLACEMENT Works GENERAL NOTES

SHEET: P-22E

OTES

1. FLARE SHOULD START AT RIGHT-OF WAY
TYPICAL, BUT CAN BE ADJUSTED TO
ACCOMMODIATE MINMAX WIDTH REQUIF R.O.W. Line -Flare (1:1 (Max 8.3%) Taper Curb (0" to 6")-PLAN VIEW #4 Bars at 18" OCEW -Contraction Joint @ Grade Break m 7% Slope -Back of Curb 2% Max 6" Lime Stabilized Subgrade Use Type "A" Hydrated Lime at 33lbs/SY Application Rate or 6" Recycled Concrete Flexible Base (Per TxDO) Item 247, Grade 1, Type D) SECTION A-A' GENERAL DESIGN STANDARDS ALLEY/STREET MESQUITE Public INTERSECTION Works ADJACENT SIDEWALK P-24

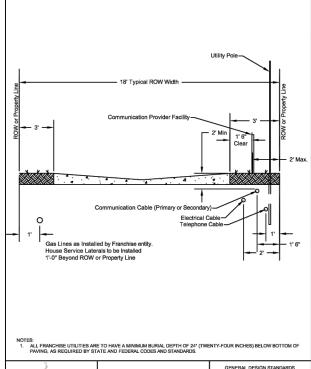

MESQUITE Public ALLEY UTILITY LOCATION Works P-25

TEXAS CITY OF MESQUITE, T PUBLIC WORKS DEPA STANDARD DETAILS