

CITY OF MESQUITE, TEXAS CDBG 2023 SIDEWALK CONSTRUCTION FOR DRIFTWOOD DR, POTTER LN, OATES DR. GROSS RD, PEACHTREE RD, N GALLOWAY AVE & OATES DR CITY CONTRACT NO. 2023-008 PROJECT

REV1 - remove sheets 4, 5. & 6. Edit Quantities. 2-23-2023

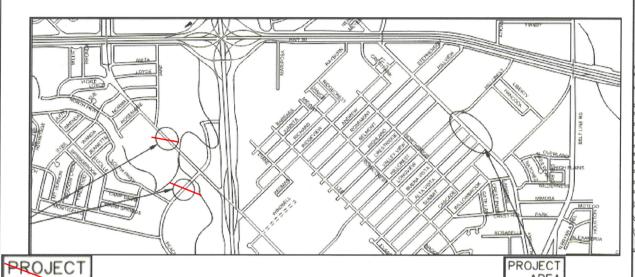

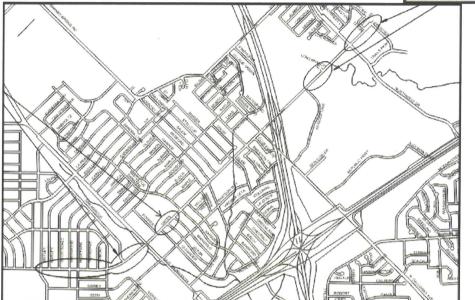

DANIEL ALEMAN JEFF CASPER KENNY GREEN JENNIFER VIDLER TANDY BOROUGHS B.W. SMITH DEBBIE ANDERSON

AREA

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CLIFF KEHELEY CURT CASSIDY, PE

CITY MANAGER PUBLIC WORKS DIR.

MAYOR

DISTRICT 1


DISTRICT 2


DISTRICT 3




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AREA

AREA
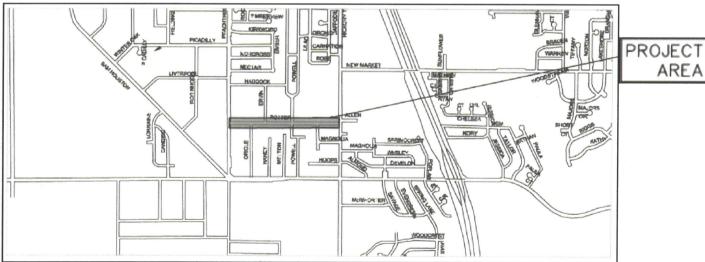
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- ALL WORK SHALL CONFORM TO THE CITY OF MESQUITE'S GENERAL DESIGN STANDARDS. IN THE EVENT AN ITEM OF WORK IS 21. NOT COVERED IN THE PLANS OR THE CITY OF MESQUITE GENERAL DESIGN STANDARDS. THE MOST CURRENT NORTH CENTRAL TEXAS COUNCIL OF GOVERNMENTS (NCTCOG) STANDARD SPECIFICATIONS FOR PUBLIC WORKS CONSTRUCTION AND THE MOST CURRENT VERSION OF TEXAS DEPARTMENT OF TRANSPORTATION STANDARD SPECIFICATIONS FOR CONSTRUCTION AND MAINTENANCE OF HIGHWAYS, STREETS, AND BRIDGES SHALL APPLY WITH CONCURRING NOTIFICATION 22. TO THE CITY ENGINEER AND THE PROJECT ENGINEER. THE CITY ENGINEER SHALL HAVE FINAL DECISION ON ALL CONSTRUCTION MATERIALS, METHODS, AND PROCEDURES.
- ALL CONTRACTORS AND DEVELOPERS. WITH THEIR EMPLOYEES AND AGENTS, SHALL COMPLY WITH ALL APPLICABLE FEDERAL, STATE AND LOCAL SAFETY LAWS AND REGULATIONS, INCLUDING BUT NOT LIMITED TO THE OCCUPATIONAL SAFETY AND HEALTH ACT OF 1970, AND ORDINANCES RULES, REGULATIONS AND ORDERS OF ANY PUBLIC AUTHORITY HAVING JURISDICTION FOR THE SAFETY OF PERSONS OR PROPERTY TO PROTECT THEM FROM DEATH IN JURY DAMAGE OR
- ALL COMMUNICATION BETWEEN THE CITY AND THE CONTRACTOR SHALL BE THROUGH THE ENGINEERING CONSTRUCTION INSPECTOR AND CITY ENGINEER ONLY. IT IS THE RESPONSIBILITY OF THE CONTRACTOR TO CONTACT THE APPROPRIATE DEPARTMENT FOR INSPECTIONS OF WORK NOT FALLING UNDER THE ENGINEERING CONSTRUCTION PERMIT
- PRIOR TO CONSTRUCTION, CONTRACTOR SHALL HAVE IN THEIR POSSESSION ALL NECESSARY PERMITS PLANS LICENSES ETC. CONTRACTOR SHALL HAVE AT LEAST ONE SET OF APPROVED ENGINEERING PLANS AND SPECIFICATIONS ON-SITE AT
- IT IS THE CONTRACTOR'S RESPONSIBILITY TO NOTIFY UTILITY COMPANIES TO ARRANGE FOR EXACT LOCATIONS AT LEAST 48 HOURS PRIOR TO BEGINNING CONSTRUCTION. THE COMPLETENESS AND ACCURACY OF THE UTILITY DATA SHOWN ON THE PLANS IS NOT GUARANTEED. THE CONTRACTOR IS RESPONSIBLE FOR VERIFYING THE DEPTH AND LOCATION OF EXISTING UNDERGROUND UTILITIES PRIOR TO EXCAVATING, TRENCHING, OR DRILLING AND SHALL BE REQUIRED TO TAKE ANY PRECAUTIONARY MEASURES TO PROTECT ALL LINES SHOWN AND / OR ANY OTHER UNDERGROUND UTILITIES NOT ON RECORD OR NOT SHOWN ON THE PLANS. THE CONTRACTOR WILL BE RESPONSIBLE FOR DAMAGES TO UTILITIES IF THE DAMAGE IS CAUSED BY NEGLIGENCE OR FAILURE TO HAVE LOCATES PERFORMED

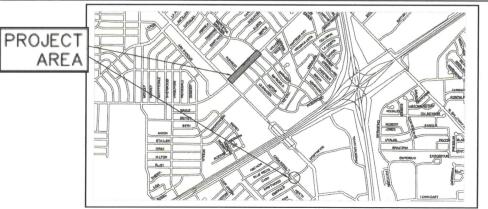CITY OF MESQUITE UTILITIES 972-216-6940 CITY OF MESQUITE TRAFFIC 972-216-6278

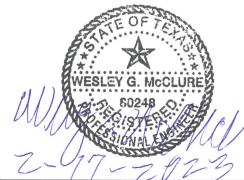- VERIFICATION OF THE CONDITION OF EXISTING CITY UTILITIES PRIOR TO CONNECTIONS SHALL BE THE RESPONSIBILITY OF THE CONTRACTOR. THE CONTRACTOR SHALL REQUEST FOR LINE LOCATES AS DIRECTED IN ITEM #5
- CONTRACTOR SHALL LOCATE AND PROTECT ALL EXISTING LANDSCAPE IRRIGATION SYSTEMS, DAMAGE TO EXISTING IRRIGATION SYSTEMS SHALL BE RESTORED TO EQUAL OR BETTER CONDITION BY A LICENSED IRRIGATOR AT THE
- CONTRACTOR SHALL BE RESPONSIBLE FOR ANY DAMAGE TO EXISTING FACILITIES OR ADJACENT PROPERTIES DURING CONSTRUCTION. ANY REMOVAL OR DAMAGE TO EXISTING FACILITIES OR ADJACENT PROPERTIES SHALL BE REPLACED OR REPAIRED TO EQUAL OR BETTER CONDITION BY THE CONTRACTOR, THE CONTRACTOR SHALL COORDINATE ALL REPAIRS TO PRIVATE PROPERTY WITH THE PROPERTY OWNER. CONTRACTOR SHALL PAY AND/OR SETTLE WITH PRIVATE PROPERTY OWNER FOR ALL COSTS RELATED TO ANY DAMAGE, FOR MORE DETAIL, REFER TO NCTCOG 107.24.
- TESTING AND INSPECTION OF MATERIALS SHALL BE PERFORMED BY A COMMERCIAL TESTING LABORATORY APPROVED BY THE CITY. CONTRACTOR SHALL FURNISH MATERIALS OR SPECIMENS FOR TESTING, AND SHALL FURNISH SUITABLE EVIDENCE THAT THE MATERIALS PROPOSED TO BE INCORPORATED INTO THE WORK ARE IN ACCORDANCE WITH THE SPECIFICATIONS. ALL TESTING AND RE-TESTING COSTS SHALL BE THE RESPONSIBILITY OF THE CONTRACTOR. FOR MORE DETAIL, REFER TO NCTCOG 106.5.
- 10. CONTRACTOR SHALL NOTIFY THE CITY AT LEAST 48 HOURS PRIOR TO BEGINNING ANY CONSTRUCTION
- ALL SHOP DRAWINGS. WORKING DRAWINGS OR OTHER DOCUMENTS WHICH REQUIRE REVIEW BY THE CITY SHALL BE SUBMITTED BY THE CONTRACTOR SUFFICIENTLY IN ADVANCE OF SCHEDULED CONSTRUCTION TO ALLOW NO LESS THAN 10 BUSINESS DAYS FOR REVIEW AND RESPONSE BY THE CITY.
- CONTRACTOR SHALL BE RESPONSIBLE FOR ALL REQUIRED CONSTRUCTION SURVEYING AND STAKING AND SHALL NOTIFY THE CITY OF ANY DISCREPANCIES PRIOR TO PROCEEDING WITH ANY WORK FOR MORE DETAIL REFER TO NCTCOG 105.4
- CONTRACTOR SHALL BE RESPONSIBLE FOR PROTECTING ALL SURVEY MARKERS INCLUDING IRON RODS, PROPERTY CORNERS, OR SURVEY MONUMENTS WITHIN THE LIMITS OF CONSTRUCTION AND OUTSIDE RIGHT-OF-WAY DURING CONSTRUCTION. ANY SURVEY MARKERS DISTURBED DURING CONSTRUCTION SHALL BE REPLACED BY THE CONTRACTOR AT NO COST TO THE CITY.
- CONTRACTOR SHALL NOT STORE MATERIALS, EQUIPMENT OR OTHER CONSTRUCTION ITEMS ON ADJACENT PROPERTIES OR RIGHT-OF-WAY WITHOUT THE PRIOR WRITTEN CONSENT OF THE PROPERTY OWNER AND THE CITY. THE PROJECT SHALL NOT BE ACCEPTED UNTIL THE CONTRACTOR PROVIDES A LETTER FROM THE PROPERTY OWNER STATING THEY ARE SATISFIED WITH THE CONDITION OF THE PROPERTY
- 15. UNUSABLE EXCAVATED MATERIAL OR CONSTRUCTION DEBRIS SHALL BE REMOVED AND DISPOSED OF OFFSITE AT AN APPROVED DISPOSAL FACILITY BY THE CONTRACTOR
- 16. ALL SIGNAGE SHALL BE INSTALLED IN ACCORDANCE WITH THE LATEST EDITION OF THE TEXAS MANUAL ON UNIFORM RAFFIC CONTROL DEVICES (TMUTCD

GENERAL NOTES FOR EROSION CONTROL/STORM WATER POLLUTION PREVENTION:

- THE CONTRACTOR SHALL COMPLY WITH THE CITY OF MESQUITE'S STORM WATER ORDINANCE, THE TDPES GENERAL CONSTRUCTION PERMIT TXR150000 AND ANY OTHER STATE AND/OR LOCAL REGULATIONS.
- CONTRACTOR IS RESPONSIBLE FOR KEEPING STREETS AND DRIVEWAYS ADJACENT TO THE PROJECT FREE OF MUD AND DEBRIS AT ALL TIMES. CONTRACTOR SHALL CLEAN UP AND REMOVE ALL LOOSE MATERIAL RESULTING FROM CONSTRUCTION OPERATIONS. STOCKPILING OR STAGING OF MATERIALS WILL NOT BE ALLOWED IN RIGHT-OF-WAY WITHOUT PRIOR AUTHORIZATION. THE CONTRACTOR SHALL TAKE ALL AVAILABLE PRECAUTIONS TO CONTROL DUST. ANY DIRT, MUD OR DEBRIS TRACKED OFFSITE SHALL BE CLEANED UP BY THE CONTRACTOR IMMEDIATELY
- ALL EROSION CONTROL DEVICES SHOWN ON THE PLANS RELEASED FOR CONSTRUCTION SHALL BE INSTALLED IN ACCORDANCE WITH THE SWPPP SEQUENCING PRIOR TO COMMENCING ANY EARTH DISTURBING ACTIVITIES. FAILURE TO NSTALL THE EROSION CONTROL DEVICES BEFORE STARTING THE EARTH DISTURBING ACTIVITIES MAY RESULT IN SANCTIONS INCLUDING, BUT NOT LIMITED TO, WITHHOLDING OF RELEASE OF CONSTRUCTION PERMITS, INSPECTIONS PAYMENT OF CITY FUNDED PORTIONS OF THE PROJECT, SUSPENSION OF CONSTRUCTION ACTIVITIES, OR CITATIONS, EROSION CONTROL DEVICES SHALL BE INSTALLED AND MAINTAINED IN COMPLIANCE WITH THE PROJECT PLANS, CITY STORMWATER ORDINANCE AND/OR SWPPP AND CONSTRUCTION GENERAL PERMIT. THE CONTRACTOR SHALL INSPECT THE SITE DAILY AND KEEP THE SITE FREE OF TRASH AND CONSTRUCTION DEBRIS
- CONTRACTOR MUST EXECUTE AND KEEP A COPY OF THE CONSTRUCTION SITE NOTICE (CSN) FOR THOSE ACTIVITIES DISTURBING MORE THAN 1 ACRE AND A NOTICE OF INTENT (NOI) FOR THOSE ACTIVITIES DISTURBING 5 ACRES OR MORE.

GENERAL NOTES FOR TRAFFIC CONTROL

- CONTRACTOR SHALL PROVIDE THE PROJECT ENGINEER WITH A TRAFFIC CONTROL PLAN AT LEAST 10 BUSINESS DAYS SEFORE ANY WORK ON A CITY STREET. TRAFFIC CONTROL MEASURES SHALL CONFORM TO THE LATEST REVISION OF THE TEXAS MANUAL ON UNIFORM TRAFFIC CONTROL DEVICES (TMUTCD)
- CONTACT TRAFFIC ENGINEERING DIVISION, 972-216-6917, AT LEAST 48 HOURS PRIOR TO WORK REQUIRING THE REMOVAL OR RELOCATION OF TRAFFIC SIGNS, TRAFFIC CONTROL EQUIPMENT OR OTHER TRAFFIC CONTROL APPURTENANCES, ONLY CITY TRAFFIC PERSONNEL SHALL REMOVE TRAFFIC SIGNS
- 23. IN THE EVENT THE CONSTRUCTION WORK REQUIRES THE CLOSURE OF AN EXISTING STREET ALLEY OR FIRE LANE. THIS CONTRACTOR SHALL REQUEST THE ROAD CLOSURE THROUGH THE CITY INSPECTOR A MINIMUM OF 48 HOURS IN ADVANCE OF THE REQUESTED CLOSURE, CLOSURES WILL NOT BE ALLOWED PRIOR TO 9:00 A M. OR AFTER 3:30 P.M. MONDAY THROUGH FRIDAY UNLESS OTHERWISE APPROVED BY THE CITY. IN THE EVENT A DRIVEWAY(S) NEEDS TO BE CLOSED, THE CONTRACTOR SHALL REQUEST THE DRIVEWAY CLOSURE THROUGH THE CITY INSPECTOR, WHO WILL IN TURN NOTIFY DISPATCH AND OTHER PERTINENT CITY DEPARTMENTS. CLOSURES ARE PROHIBITED DURING SCHOOL ZONES TIMES IN AND
- 24. IF THE CONSTRUCTION ZONE AFFECTS THE MOVEMENTS OF PEDESTRIANS, ADEQUATE PEDESTRIAN ACCESS AND WALKWAYS SHALL BE PROVIDED IN ACCORDANCE WITH THE DISABILITIES ACT ACCESSIBILITY GUIDELINES, PROWAG, TAS AND THE TMUTCD. WHERE DEVELOPMENTS OCCUR WITHIN 0.5 MILES OF A SCHOOL SITE, TEMPORARY SIDEWALKS MUST BE CONSTRUCTED CONNECTING THE DEVELOPMENT TO THE SCHOOL SITE. THE ROUTE SHALL BE APPROVED BY THE CITY ENGINEER, TEMPORARY SIDEWALKS MAY BE CONSTRUCTED WITH MATERIALS OTHER THAN CONCRETE THE MATERIAL SHALL BE APPROVED BY THE CITY ENGINEER AND BE AN ALL-WEATHER MATERIAL OF A COLOR AND TEXTURE DISTINCTLY DIFFERENT FROM THE PERMANENT SIDEWALK.
- OVERNIGHT LANE CLOSURES SHALL BE APPROVED BY CITY PRIOR TO CLOSING THE LANE. ANY LANE OR SHOULDER CLOSURE ON AN ARTERIAL ROAD THAT EXTENDS INTO THE NIGHT SHALL REQUIRE THE MANDATORY USE OF ARROW

GENERAL NOTES FOR PAVING

- 26. ABSOLUTELY NO EARTHWORK, LIME APPLICATION, OR OTHER PREPARATION OF THE SUBGRADE FOR PAVING OF STREETS, ALLEYS, SIDEWALKS, TRAILS, FIRE LANES OR OTHER TRANSPORTATION RELATED FLATWORK SHALL BE INITIATED WITHOUT AUTHORIZATION FROM THE CITY. THE CITY WILL AUTHORIZE THE SUBGRADE WORK IN PREPARATION FOR PAVING AFTER UTILITY TRENCH BACKFILL TESTING HAS BEEN COMPLETED AND VERIFIED TO MEET THE CITY REQUIREMENTS.
- ALL SIDEWALKS SHALL COMPLY WITH THE AMERICANS WITH DISABILITIES ACT AND THE TEXAS ARCHITECTURAL BARRIERS ACT. THE CITY OF MESQUITE HAS NOT REVIEWED THESE PLANS FOR COMPLIANCE WITH THE AMERICANS WITH DISABILITIES ACT, TEXAS ARCHITECTURAL BARRIERS ACT, OR ANY OTHER ACCESSIBILITY LEGISLATION, AND DOES NOT WARRANTY OR APPROVE THESE PLANS FOR ANY ACCESSIBILITY STANDARDS. PRIOR TO PROJECT ACCEPTANCE, THE CONTRACTOR SHALL SUBMIT TO THE CITY DOCUMENTATION THAT THE PROJECT WAS INSPECTED BY A REGISTERED ACCESSIBILITY SPECIALIST, REGISTERED WITH THE TEXAS DEPARTMENT OF LICENSING AND REGULATION CERTIFYING THE PROJECT IS IN COMPLIANCE WITH THE REQUIREMENTS OF THE TEXAS ARCHITECTURAL BARRIERS ACT.
- ALL CONCRETE PAVING (STREETS, ALLEYS, SIDEWALKS, DRIVEWAYS) WITHIN CITY ROW SHALL HAVE A 28 DAY MINIMUM COMPRESSIVE STRENGTH OF 4,000 PSI, CONTAINING A MINIMUM OF 6 SACKS OF CEMENT PER CUBIC YARD, WITH A SLUMP RANGE OF 1" TO 3" SLUMP FOR MACHINE POURS AND 3" TO 5" SLUMP FOR HAND POURS UNLESS OTHERWISE NOTED IN THE GENERAL DESIGN STANDARDS, ALL MATERIALS AND REQUIREMENTS FOR CONCRETE SHALL CONFORM TO THE REQUIREMENTS OF THE CURRENT NCTCOG ITEM "PORTLAND CEMENT CONCRETE PAVEMENT" WITH THE EXCEPTION THAT FLY ASH MAY BE SUBSTITUTED FOR UP TO 20% OF THE CEMENT CONTENT REQUIREMENT AT 1 TO 1.25 CEMENT TO FLY ASH SUBSTITUTION RATE
- 29. ALL CONCRETE MUST BE MECHANICALLY VIBRATED. THE FORMING OF NEW STREET AND ALLEY PAVEMENT IS BY USING THE SLIP FORM METHOD. CONCRETE SHALL BE HAND PLACED AT INTERSECTIONS AND MISCELLANEOUS AREAS
- 30 TEMPERATURE DURING CONCRETE PLACEMENT
- THE TEMPERATURE OF CONCRETE AS PLACED SHALL NOT EXCEED 95°F.
 - NO CONCRETE SHALL BE PLACED ON A FROZEN SUBGRADE.
 - IF THE AMBIENT AIR TEMPERATURE IS LESS THAN 40°F AND DROPPING CONCRETE SHALL NOT BE PLACED.

 IF CONCRETE IS PLACED AND THERE IS AN ANTICIPATED LOW TEMPERATURE OF LESS THAN 40°F WITHIN 5 DAYS.
 - AFTER PLACEMENT THE CONCRETE MUST BE COVERED AND KEPT AT A TEMPERATURE OF NOT LESS THAN 50°F.
 IN ALL CASES, CONCRETE SHOULD NOT BE KEPT AT A TEMPERATURE OF LESS THAN 50°F FOR A PERIOD OF 5 DAYS
- REINFORCING SHALL CONFORM TO ASTM A 615 AND BE A MINIMUM GRADE OF 60 PER ASTM A 370. REINFORCING STEEL BAR
- LAPS ARE TO BE 30 BAR DIAMETERS OR 15" PER ACI 318, WHICHEVER IS GREATER. A MINIMUM OF 50% OF REBAR INTERSECTIONS ARE TO BE SECURED WITH TIE WIRE AND SUPPORTED WITH CHAIRS. ALL REINFORCEMENT SHALL BE FREE FROM RUST, SCALE, OIL, PAINT AND OTHER SUBSTANCES WHICH PREVENT BONDING TO THE CONCRETE. UNLESS OTHERWISE SPECIFIED, STEEL SHALL BE PLACED AT HALF THE PAVEMENT DEPTH
- WHITE CURING COMPOUND IS TO BE APPLIED, PER MANUFACTURER'S RECOMMENDATIONS, TO ALL EXPOSED CONCRETE SURFACES (INCLUDING BACKS OF CURBS) IMMEDIATELY AFTER COMPLETION OF FINISHING OPERATIONS, PER ASTM C-309, TYPE 2, NCTCOG SECTION 303,2,13,1,1,
- NO VEHICLE TRAFFIC SHALL BE PERMITTED ON NEWLY PAVED AREAS FOR SEVEN DAYS AFTER CONCRETE POUR OR UNTIL 3.000 PSI IS ACHIEVED.
- ALL FILL AND LIME SUBGRADES SHALL BE PLACED IN MAXIMUM 8" COMPACTED LIFTS AND BE COMPACTED TO 95% STANDARD PROCTOR AT A MOISTURE RANGE OF 0% TO 5% OF OPTIMUM MOISTURE. MOISTURE LEVEL MUST BE MAINTAINED, BY WETTING OR APPLICATION OF ASPHALT EMULSION PRIME COAT (0.25 TO 0.50 GAL/SY) IF NECESSARY, UNTIL PLACING OF CONCRETE PAVING

GENERAL NOTES FOR TRENCHING AND CONFINED SPACE

- ALL EXCAVATION AND TRENCH OPERATIONS SHALL BE CONDUCTED IN ACCORDANCE WITH 29 CODE OF FEDERAL REGULATIONS (CFR), PART 1926, SUBPART P AND ALL OTHER APPLICABLE STATE AND CITY REGULATIONS, PRIOR TO COMMENCING ANY EXCAVATION OR TRENCHING OPERATION, THE CONTRACTOR SHALL SUBMIT TO THE CITY ENGINEER A PLAN SEALED BY A TEXAS LICENSED PROFESSIONAL ENGINEER INDICATING THE INTENDED PROCEDURES TO BE USED BY THE CONTRACTOR TO COMPLY WITH OSHA REQUIREMENTS. SUCH PLAN SHALL FURTHER IDENTIFY THE "COMPETENT PERSON" AS REQUIRED BY PARAGRAPH 1926.651(K)(1) THAT WILL WORK WITH EACH CREW. AN AFFIDAVIT FROM THE CONTRACTOR INDICATING THE COMPETENT PERSON MUST BE SUBMITTED WITH THE TRENCH SAFETY PLAN TO THE CITY ENGINEER. A COPY OF THE TRENCH SAFETY PLAN MUST BE ON THE JOB AT ALL TIMES, THE CITY RESERVES THE RIGHT TO DENY PAYMENT FOR ANY CONSTRUCTION ACTIVITIES IN EXCAVATIONS OR TRENCHES THAT ARE NOT IN ACCORDANCE WITH THE SUBMITTED PLAN. THE CITY DOES NOT APPROVE OR DISAPPROVE TRENCH SAFETY PLANS, BUT WILL RETAIN A FILE
- IMPLEMENTATION OF TRENCH SAFETY SHALL COMPLY WITH SUBMITTED TRENCH SAFETY DESIGN PLAN, SUBMIT DESIGNATED COMPETENT PERSON WHO WILL BE ON-SITE FULL TIME AND IS CAPABLE OF IDENTIFYING EXISTING AND PREDICTABLE HAZARDS IN SURROUNDING OR WORK CONDITIONS WHICH ARE UNSANITARY, HAZARDOUS, OR DANGEROUS TO EMPLOYEES AND WHO HAS THE AUTHORIZATION TO TAKE PROMPT CORRECTIVE MEASURES TO FUMINATE THEM INSTALL, OPERATE, MAINTAIN, ADJUST, AND REMOVE TRENCH SAFETY EQUIPMENT, AND PRECAUTIONS IN ACCORDANCE
- ALL ENTRY INTO CONFINED SPACES SHALL BE CONDUCTED IN ACCORDANCE WITH 29 CODE OF FEDERAL REGULATIONS (CFR), PART 1910.147 P AND ALL OTHER APPLICABLE STATE AND CITY REGULATIONS, PRIOR TO COMMENCING ANY CONFINED SPACE ENTRY, THE CONTRACTOR SHALL SUBMIT TO THE CITY ENGINEER A COPY OF THE CONFINED SPACE ENTRY PLAN WITH A COMPLETED PERMIT

GENERAL NOTES FOR UTILITIES

ALL WATER AND WASTEWATER MAINS THAT ARE PROPOSED TO BE ABANDONED WITHIN STREET ROW AND LESS THAN 10 FEET IN DEPTH, UNDER ANY MAJOR INTERSECTIONS, OR IN AREAS THAT COULD IMPACT MAJOR INFRASTRUCTURE, SHALL BE ABANDONED BY DRAINING THE EXISTING MAIN AND CUTTING AND FILLING THE EXISTING MAIN WITH GROUT

			REQUIRED	TESTING	
MATERIAL	DESIGNATION	TEST	FREQUENCY	REQUIREMENTS	NOTES
		IN-PLACE DENSITY AND WATER CONTENT		MOISTURE CONTENT: 0% - 6% OF OPTIMUM; DENSITY: 95% OF STANDARD PROCTOR	EVERY 8" LIFT
SUBGRADE	ASTM D-6938	CHECK	EVERY 300 LINEAR FEET (1)	DEPTH OF STABILIZATION AS SPECIFIED PER PLANS	
		LIME STABILIZED SUBGRADE - SIEVE ANALYSIS		1.75" SIEVE: 100% PASSING; NO. 4 SIEVE: 60%	
	ASTM D-698	PROCTOR	EVERY NEW MATERIAL SOURCE		
	ASTM C- 143	SLUMP OF PORTLAND CEMENT	FIRST TRUCK EACH DAY + 1 EVERY 150 CY	1" - 3" MACHINE POURS; 3" - 5" HAND POURS	
	ASTM C-231	CONCRETE AIR CONTENT BY PRESSURE METHOD (FOR FRESH CONCRETE)	FIRST INDEX EACH DAT + 1 EVERT 130 CT	MINIMUM 3%	
		TEMPERATURE OF FRESHLY MIXED PORTLAND CEMENT CONCRETE	EVERY TRUCK	95 F MAX (HOT WEATHER) AND 50 F MIN (COLD WEATHER)	
CONCRETE PAVING		COMPRESSIVE STRENGTH OF CYLINDRICAL CONCRETE SPECIMENS	3 CYLCINDERS TAKEN FROM FIRST TRUCK EVERY DAY + 3 EVERY 150 CY	3,000 PSI MINIMUM FOR TRAFFIC; 4,000 PSI MINIMUM AT 28 DAYS	1 BROKEN AT 7 DAYS AND THE OTHER 2 BROKEN AT 28 DAYS; IF NEEDING TO GET TRAFFIC ON PAVEMENT FASTER THEN ADDITIONAL CYLINDER BROKEN AT 3 DAYS
		OBTAINING AND TESTING OF DRILLED CORES OF CONCRETE	EVERY 300 LINEAR FEET (1)	4,000 PSI COMPRESSIVE AT 28 DAYS	4" DIAMETER TAKEN 28 DAYS AFTER POUR
		MEASURING LENGTH OF DRILLED CONCRETE CORES	EVENT 300 LINEAR FEET (1)	DEPTH OF PAVEMENT AS SPECIFIED PER PLANS	

ES: (1) PER LANE, TRENCH, ALLEY OR SIDEWALK

BENERAL DESIGN STANDARD G-GN CITY OF MESQUITE, TEXAS PUBLIC WORKS DEPARTMENT STANDARD DETAILS

GENERAL

MESQUITE

REV1 - remove sheets 4, 5, & 6. Edit Quantities. 2-23-2023

		1				Bid-Al	It Items								2 20 20		
ITEM	DESCRIPTION	UNIT	1	-	- 4				SHEET NUMBER								
1	MOBILIZATION (5% OF TOTAL)	LS	4	3	6	7	8	9	10	11	12	13	14	15	16	17	18
2	TRAFFIC CONTROL IMPLEMENTATION AND MAINTENANCE	LS	+ \ -	-	- /	-		-	-	-	-	-	-	-	-	-	
_	REMOVE CONCRETE INCLUDING SIDEWALK, DRIVEWAY, ALLEY,	- 63	 \ -	-	-/-	-	-	-	-	-	-	-	-	—	-		-
3	PAVEMENT, OTHER	SY	-	-	/-	130	22	-	-	27	6	100	60	73			+ -
4	CONSTRUCT CONCRETE SIDEWALK (4" THICK)	SY	103	103	65	93	133	140	-			100	00	/3	-	77	-
5	CONSTRUCT CONCRETE SIDEWALK (6" THICK)	SY	-	-	1/ 33	-		140	40	-	6	7	-	40	120	39	128
6	CONSTRUCT ADA RAMP TYPE A	EA	-	1			-	-	-	-	-	-	-	-	-	-	-
7	CONSTRUCT ADA RAMP TYPE C	EA	-			-	-	-	-	-	-	-	-	-	-	-	-
8	CONSTRUCT ADA RAMP TYPE D	EA	1 -				-	-	-	-	1	-	-	-	-	-	-
0	CONSTRUCT CONCRETE ALLEY/DOWN	***************************************				-	-	1	2	2	-	-	-	-	-	-	1
	CONSTRUCT CONCRETE ALLEY/DRIVEWAY APPROACH (6" THICK)	SY	-		-	123	22	-	-	27	-	100	60	73		77	
10	ADJUST MANHOLE AND COVER	EA	-	-	1	-	-	-						/3		//	-
11	ADJUST WATER VALVE STACK TOP	EA	-	_	-	_			-	-	-	- 1	-	-	-	-	-
12	ADJUST WATER METER	EA	- /	-	-			-	-	-	-	1	-	-	-	-	-
13	BERMUDA BLOCK SOD	SF	500	600	200	400	700	400	-	-	-	1	-	-	-	-	-
14	REMOVE EXISITNG HEADWALL AND TREES IN ROW	LS	-/	-	1	-	$+$ 1 $^{\circ}$ $+$	400	200	60	20	20	20	300	600	200	600
15	EXTEND 24" RCP	LF		-		-	H 10 F	-	-	-	-	-	-	-	-	-	-
16	EXTEND 18" RCP W/45 DEGREE BEND	LF	-	_		-	H 10 F	-	-	-	-	-	-	-	-	-	-
17	CONSTRUCT CONCRETE HEADWALL (CH-PW-0)(4:1)(H=6')	LS	-	-		-	┤┤╵	-	-	-	-	-	-	-	-	-	-
18	PEDESTRIAN HANDRAIL (TY C)	LF	-	-		-	H], -	-	-	-	-	-	-	-		-	-
			7			-	<u> </u>	-	-	-	-	-	-	-	-	-	_

ITEM	DESCRIPTION	UNIT	19	20	T 24						SHEET	NUMBER			Separation of the second					N. A. S.	
1	MOBILIZATION (5% OF TOTAL)	LS			21	22	23	24	25	26	27	28	29	30	21	32	22	T		1	ESTIMATED
2	TRAFFIC CONTROL IMPLEMENTATION AND MAINTENANCE	LS	-	-	-	-	-	-	-	-	-	-	-	-	31	32	33	34	35	36	PLAN QTY
	REMOVE CONCRETE INCLUDING SIDEWALK, DRIVEWAY, ALLEY,	LS	-	-	-	-	-	-	-	-	-	-				-	-	-	-	-	1
3	PAVEMENT, OTHER	SY	-	-	-	-	-	-	-		20	10		40	40	-	-	-	-	-	1
4	CONSTRUCT CONCRETE SIDEWALK (4" THICK)	SY	276	213	100	187	27	110						40	40	60	30	60	60	30	845
5	CONSTRUCT CONCRETE SIDEWALK (6" THICK)	SY	-		-	107	21	110	104	83	171	284	136	-	-	-		-	-	-	2437
6	CONSTRUCT ADA RAMP TYPE A	EA	-		-	-	-	-	-	-	-	-	-	326	405	504	91	536	548	163	2572
7	CONSTRUCT ADA RAMP TYPE C	EA	-		-		-	-	1	-	-	-	-	-	-	-		-	-	103	2573
8	CONSTRUCT ADA RAMP TYPE D	EA	-		1		-	-	-	1	-	-	-	-	-	-	-		-		+
9	CONSTRUCT CONCRETE ALLEY/DRIVEWAY APPROACH (6" THICK)	SY				-		2	1	-	6	6	2	-	1	1	1	1	-	1	30
		31	-		-	-	-	-	-	-	-	-	- 1	_							
10	ADJUST MANHOLE AND COVER	EA	-	-	-	-	-	_	-								-	-	-	-	482
11	ADJUST WATER VALVE STACK TOP	EA	-	-		1	-		+ -	-	-	-	-	-	-	-	2	1	-	-	4
12	ADJUST WATER METER	EA		-	-	-		-	-	-	-	-	-	3		1	1	1	2		10
13	BERMUDA BLOCK SOD	SF	700	700	500	600	200	500	400	-	-	-	-	-	-	-	-	-			10
14	REMOVE EXISITNG HEADWALL AND TREES IN ROW	LS	-	-	-		200		400	166	342	476	192	452	623	631	124	776	828	238	1 11,968
15	EXTEND 24" RCP	LF		_	-			-	-	H	-	-	-	-	-	-	-	-	-	238	11,900
16	EXTEND 18" RCP W/45 DEGREE BEND	LF	-	-	-		-	-	-	 	-	-	-			-	-	-	-	-	10
17	CONSTRUCT CONCRETE HEADWALL (CH-PW-0)(4:1)(H=6')	LS	-	-			-	-	-	-	-	-	-	-		-	-	-		-	-
18	PEDESTRIAN HANDRAIL (TY C)	LF	-	-	-		-	-	-	H -	-	-	-	-	-	-	-	-		-	10
						-	-		-		-	-	- 1	-					-	-	30



Public Works

ESTIMATED QUANTITIES

CDBG 2023 SIDEWALK IMPROVEMENT PROJECT CITY CONTRACT #2023-008


SCALE - 1" = NTS

DRAWN BY:

REVISIONS

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DATE 2/17/2023



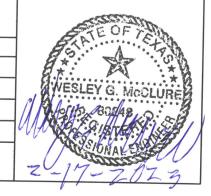








DRIVEWAY/ STREET APRON

BLOCK SODDING



CURB RAMP

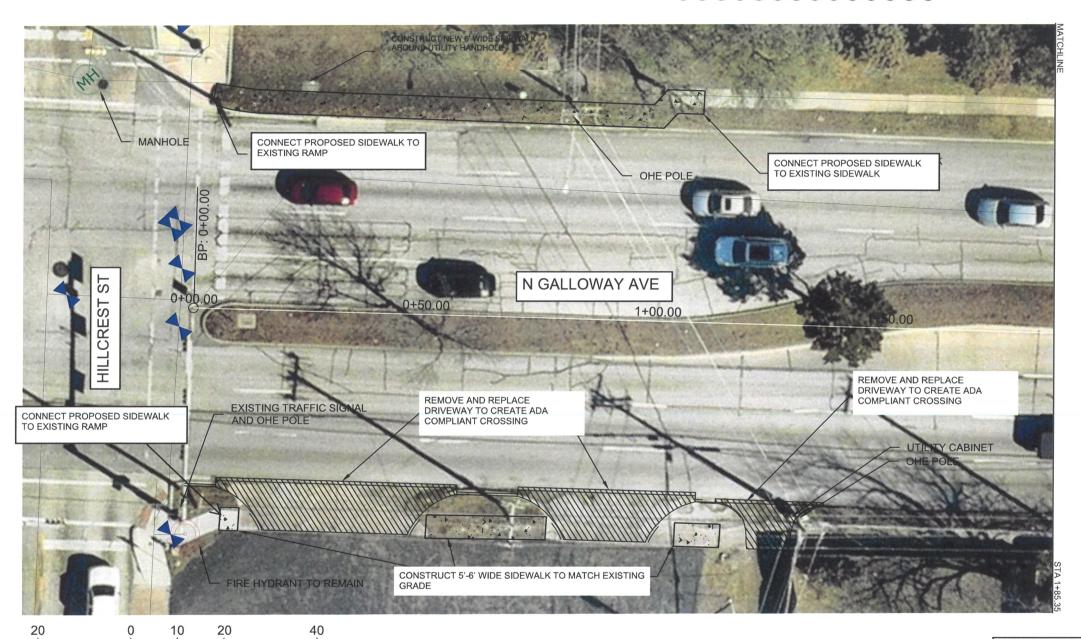

GENERAL NOTES:

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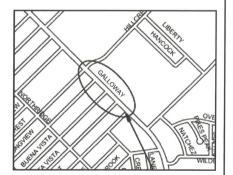
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PROJECT NOTES:

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- 2. INSTALL A.D.A. COMPLIANT RAMPS AT LOCATIONS SHOWN. REFER TO DESIGN DETAIL SHEET
- 3. TIE NEW SIDEWALK TO EXISTING SIDEWALK OR OTHER EXISTING CONNECTION
- 4. REMOVE AND REPLACE DRIVEWAY, REFER TO MESOUITE DESIGN DETAIL SHEET

PROJECT LOCATION



CDBG 2023 SIDEWALK IMPROVEMENT PROJECT CITY CONTRACT #2023-008

SCALE - 1" = 20'

DRAWN BY:

REVISIONS

2/17/2023

SHEET: 7




Public Works

1 inch = 20 ft.

N. GALLOWAY AVE (1) - SIDEWALKS





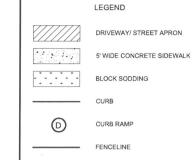



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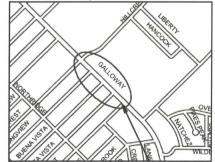
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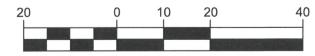
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PROJECT LOCATION





1 inch = 20 ft.



Public Works


N. GALLOWAY AVE (2) - SIDEWALKS

CDBG 2023 SIDEWALK IMPROVEMENT PROJECT CITY CONTRACT #2023-008

SCALE - 1" = 20'

REVISIONS

DATE 2/17/2023

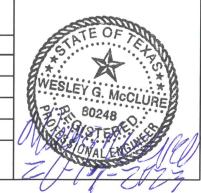



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DRIVEWAY/ STREET APRON

5' WIDE CONCRETE SIDEWALK

BLOCK SODDING





GENERAL NOTES:


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PROJECT LOCATION



CDBG 2023 SIDEWALK IMPROVEMENT PROJECT CITY CONTRACT #2023-008

SCALE - 1" = 20'

DRAWN BY:

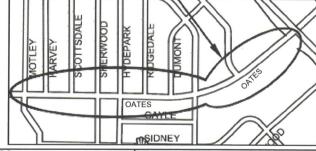REVISIONS

DATE 2/17/2023

SHEET: 9

Public Works

1 inch = 20 ft.

MESQUITE

Real. Texas. Service.

OATES DR SOUTH (1) - SIDEWALKS








DRIVEWAY/ STREET APRON 5' WIDE CONCRETE SIDEWALK

BLOCK SODDING

FENCELINE

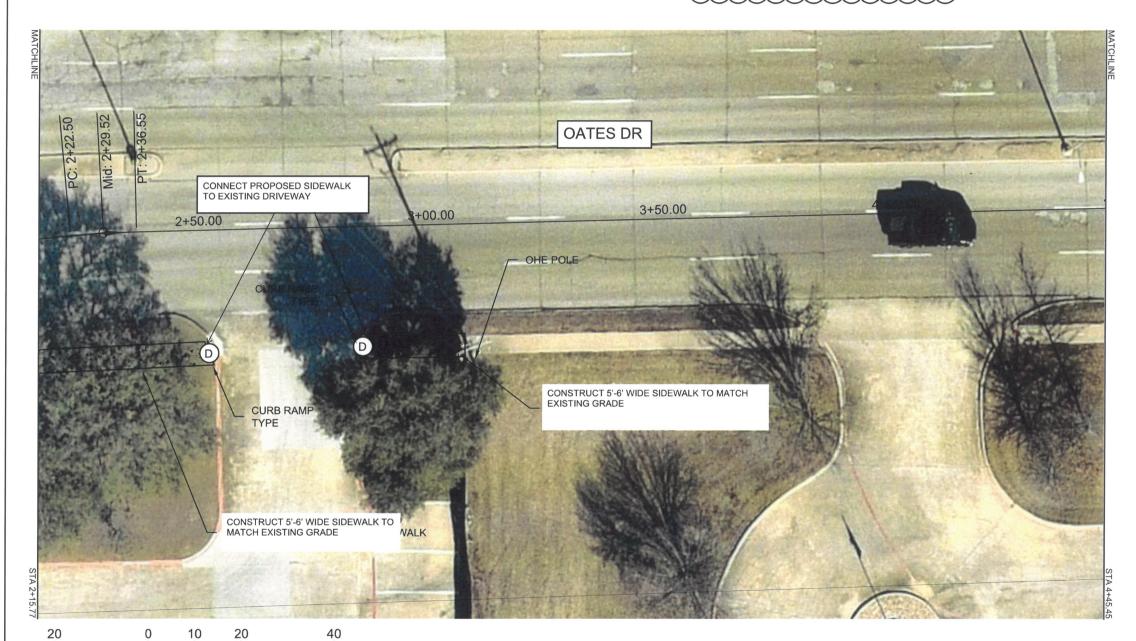

GENERAL NOTES:

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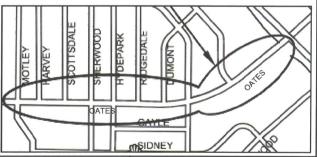
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PROJECT LOCATION



CDBG 2023 SIDEWALK IMPROVEMENT PROJECT CITY CONTRACT #2023-008

SCALE - 1" = 20'

DRAWN BY:

SHEET: 10

REVISIONS

DATE 2/17/2023

Real. Texas. Service.


Public Works

1 inch = 20 ft.

OATES DR SOUTH (2) - SIDEWALKS





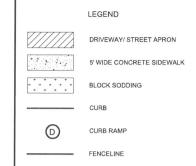



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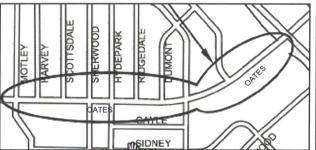
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PROJECT LOCATION



CDBG 2023 SIDEWALK IMPROVEMENT PROJECT CITY CONTRACT #2023-008

SCALE - 1" = 20'

DRAWN BY:

REVISIONS

DATE 2/17/2023

SHEET: 11



Public Works


1 inch = 20 ft.


OATES DR SOUTH (3) - SIDEWALKS



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GENERAL NOTES:

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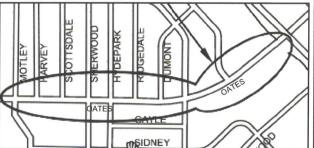
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PROJECT LOCATION

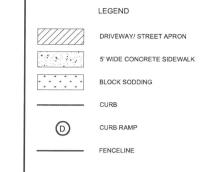

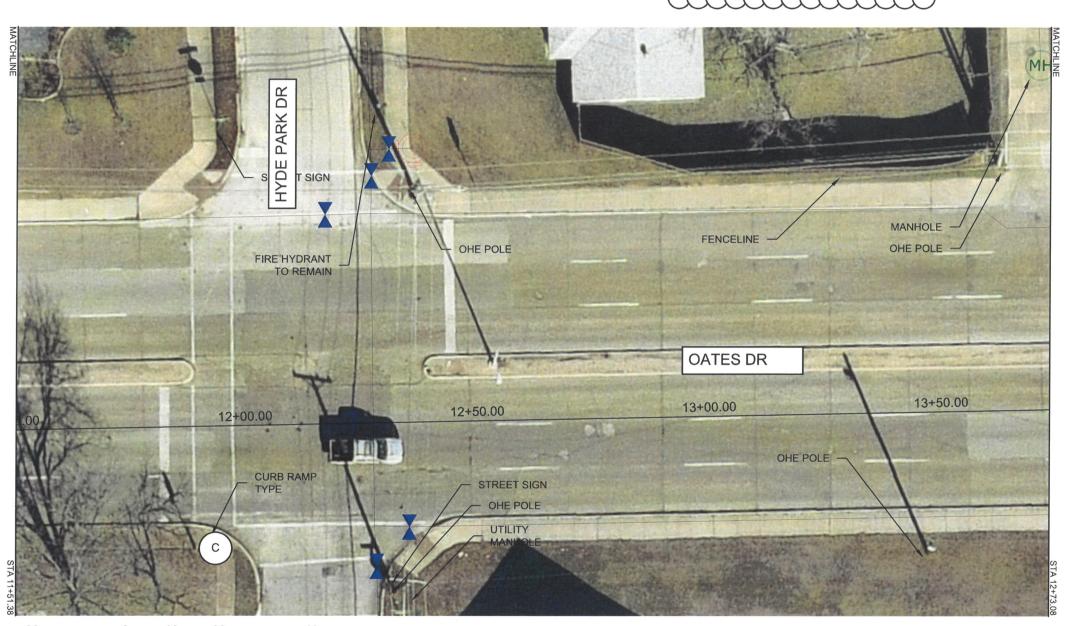CDBG 2023 SIDEWALK IMPROVEMENT PROJECT CITY CONTRACT #2023-008

SCALE - 1" = 20'

DRAWN BY:


REVISIONS

DATE

2/17/2023

SHEET: 12



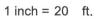



Public Works

OATES DR SOUTH (4) - SIDEWALKS







GENERAL NOTES:

DRIVEWAY/ STREET APRON

LEGEND

5' WIDE CONCRETE SIDEWALK

BLOCK SODDING



CURB RAMP




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PROJECT LOCATION



CDBG 2023 SIDEWALK IMPROVEMENT PROJECT CITY CONTRACT #2023-008

SCALE - 1" = 20'


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REVISIONS

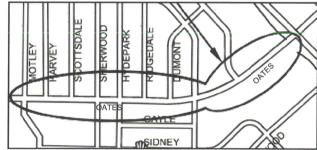DATE

2/17/2023

SHEET: 13

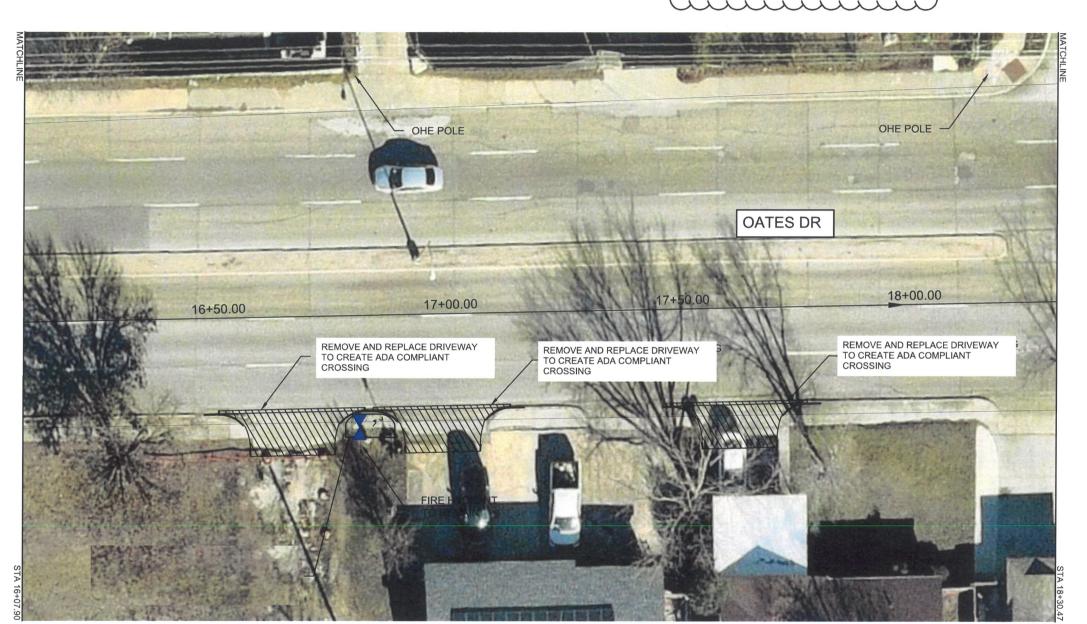

1 inch = 20 ft.



Public Works

OATES DR SOUTH (5) - SIDEWALKS








DRIVEWAY/ STREET APRON

5' WIDE CONCRETE SIDEWALK



BLOCK SODDING



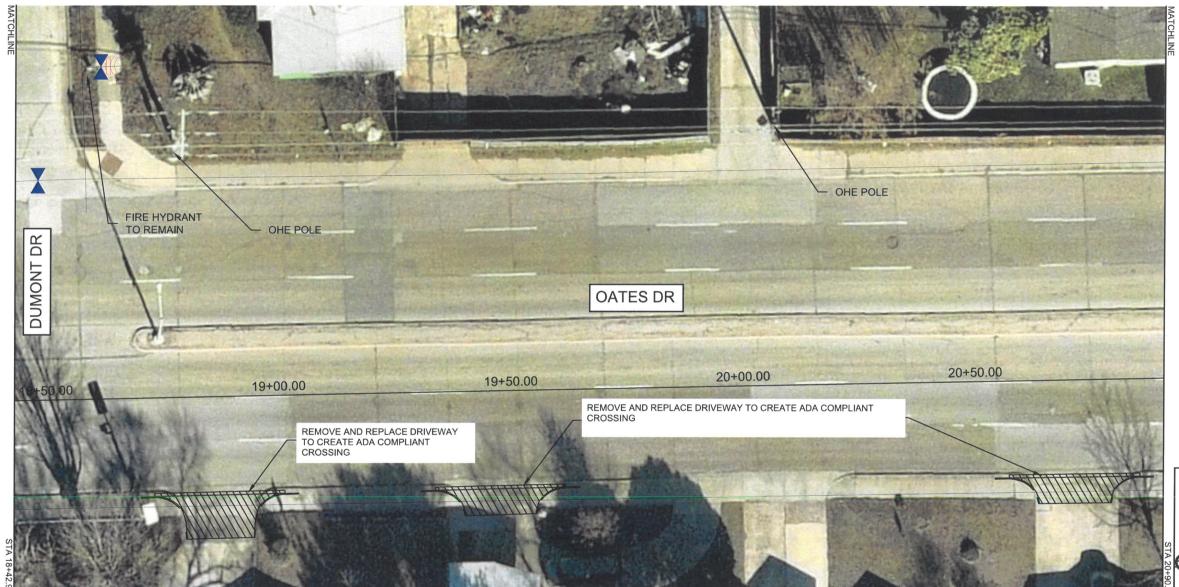

GENERAL NOTES:


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PROJECT LOCATION



CDBG 2023 SIDEWALK IMPROVEMENT PROJECT CITY CONTRACT #2023-008


SCALE - 1" = 20'

DRAWN BY:

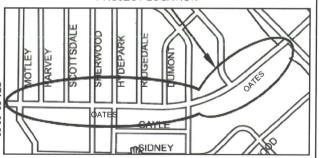REVISIONS

2/17/2023

SHEET: 14

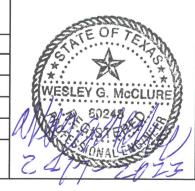




Public Works


1 inch = 20 ft.

OATES DR SOUTH (6) - SIDEWALKS





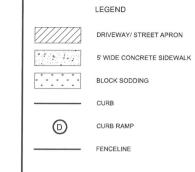

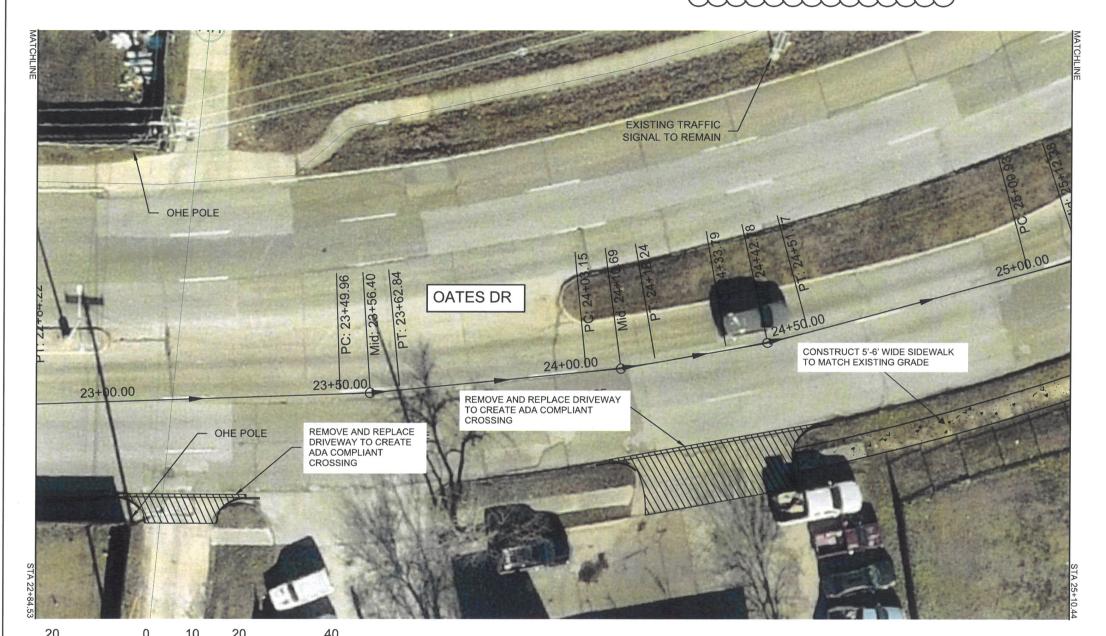

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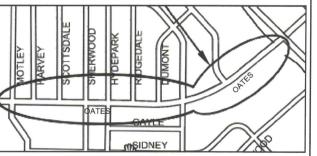
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- 3. TIE NEW SIDEWALK TO EXISTING SIDEWALK OR OTHER EXISTING CONNECTION POINTS AS SHOWN AND REQUIRED
- 4. REMOVE AND REPLACE DRIVEWAY, REFER TO MESQUITE DESIGN DETAIL SHEET

PROJECT LOCATION



CDBG 2023 SIDEWALK IMPROVEMENT PROJECT CITY CONTRACT #2023-008

SCALE - 1" = 20'

DRAWN BY:

REVISIONS

DATE 2/17/2023

SHEET: 15



Public Works

1 inch = 20 ft.

OATES DR SOUTH (7) - SIDEWALKS



> CONSTRUCT 5'-6' WIDE SIDEWALK TO MATCH **EXISTING GRADE**

27+00.00

FIRE HYDRANT

TO REMAIN

STREET SIGN

 \sim





LEGEND



5' WIDE CONCRETE SIDEWALK



BLOCK SODDING



CURB RAMP



FENCELINE

GENERAL NOTES:

- NO FRANCHISE UTILITIES HAVE BEEN LOCATED OR SHOWN ON THESE PLANS. CONTRACTOR IS RESPONSIBLE FOR RELOCATION OF ANY SIGNS AND
- CONTRACTOR IS RESPONSIBLE FOR RELOCATION OF ANY SIGNS AND COORDINATION WITH THE CITY FOR ANY MODIFICATIONS.


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 SERVICE LOCATIONS HAVE NOT BEEN LOCATED AND ARE SHOWN.
- SERVICE LOCAL IONS HAVE NOT BEEN LOCALED AND ARE SHOWN
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 THE CONTRACTOR SHALL DETERMINE DEPTH AND LOCATION OF EXISTING
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PROJECT LOCATION



CDBG 2023 SIDEWALK IMPROVEMENT PROJECT CITY CONTRACT #2023-008

SCALE - 1" = 20'

REVISIONS

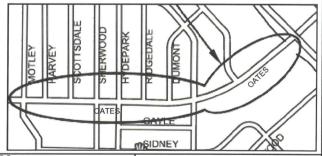SHEET: 16 DATE



20

25+50.00

Public Works 26+00.00

CONSTRUCT 5'-6' WIDE SIDEWALK TO

FENCELINE

MATCH EXISTING GRADE

OATES DR SOUTH (8) - SIDEWALKS

OATES DR

CONNECT PROPOSED SIDEWALK TO

26+50.00







DRIVEWAY/ STREET APRON

BLOCK SODDING

LEGEND



CURB RAMP



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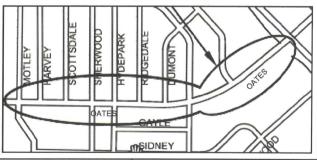
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PROJECT LOCATION



CDBG 2023 SIDEWALK IMPROVEMENT PROJECT CITY CONTRACT #2023-008

SCALE - 1" = 20'

DRAWN BY:

REVISIONS

DATE 2/17/2023



Public Works

1 inch = 20 ft.

OATES DR SOUTH (9) - SIDEWALKS







DRIVEWAY/ STREET APRON 5' WIDE CONCRETE SIDEWALK BLOCK SODDING



GENERAL NOTES:

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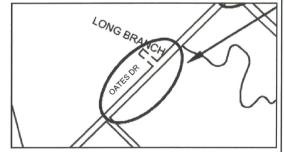
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PROJECT LOCATION



CDBG 2023 SIDEWALK IMPROVEMENT PROJECT CITY CONTRACT #2023-008

SCALE - 1" = 20'

DRAWN BY:

REVISIONS

DATE 2/17/2023

SHEET: 18



Public Works

1 inch = 20 ft.

OATES DR NORTH (1) - SIDEWALKS








BLOCK SODDING

5' WIDE CONCRETE SIDEWALK



FENCELINE

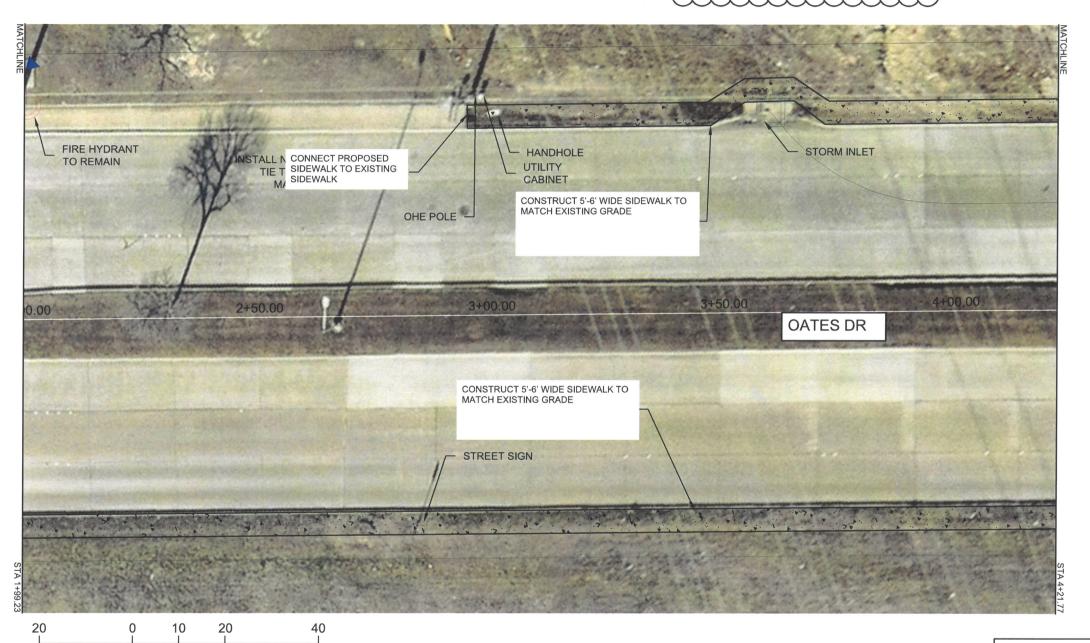

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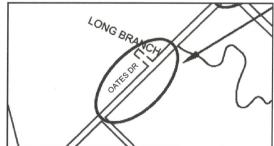
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PROJECT LOCATION



CDBG 2023 SIDEWALK IMPROVEMENT PROJECT CITY CONTRACT #2023-008 SCALE - 1" = 20'

REVISIONS

DRAWN BY:

2/17/2023

SHEET: 19



Public Works


1 inch = 20 ft.

OATES DR NORTH (2) - SIDEWALKS



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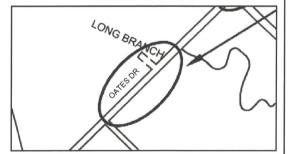
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PROJECT LOCATION

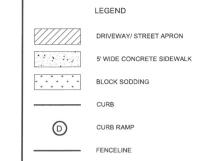

CDBG 2023 SIDEWALK IMPROVEMENT PROJECT CITY CONTRACT #2023-008

SCALE - 1" = 20'

DRAWN BY:

REVISIONS

DATE 2/17/2023

SHEET: 20



MESQUITE T E X A S Real. Texas. Service.

Public Works

1 inch = 20 ft.

OATES DR NORTH (3) - SIDEWALKS



6+50.00

OVERHEAD AND UNDERGROUND **UTILITIES THROUGHOUT** PROJECT LOCATION


FIRE HYDRANT

CONNECT PROPOSED SIDEWALK TO EXISTING DRIVEWAY

STORMINLET





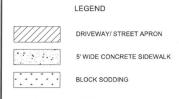

CURB RAMP

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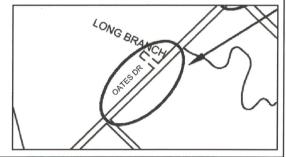
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PROJECT LOCATION



CDBG 2023 SIDEWALK IMPROVEMENT PROJECT

SCALE - 1" = 20'

REVISIONS



UTILITY CABINET

OATES DR

CONSTRUCT 5'-6' WIDE SIDEWALK TO

MATCH EXISTING GRADE

7+50.00

STORM INLET -

MESQUITE T E X A S Real. Texas. Service.

Public Works

1 inch = 20 ft.

OHE POLE

UTILITY CABI

STORM INLET

CITY CONTRACT #2023-008 DRAWN BY: DATE **SHEET: 21** 2/17/2023







DRIVEWAY/ STREET APRON

5' WIDE CONCRETE SIDEWALK




BLOCK SODDING





FENCELINE

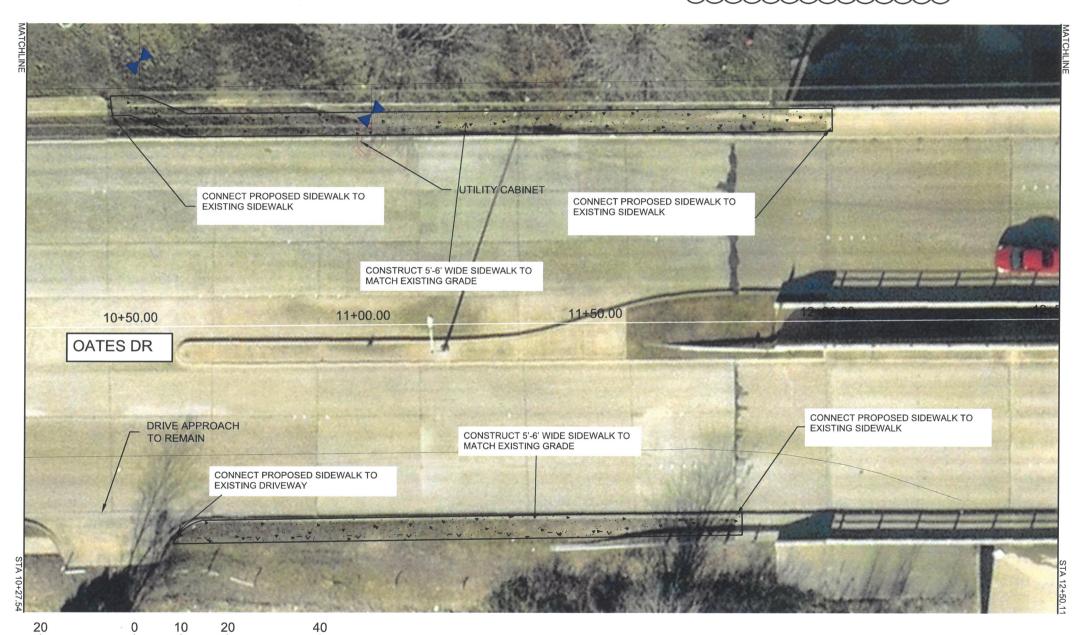

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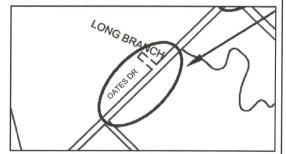
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PROJECT LOCATION



CDBG 2023 SIDEWALK IMPROVEMENT PROJECT CITY CONTRACT #2023-008

SCALE - 1" = 20'

DRAWN BY:

REVISIONS

DATE 2/17/2023

SHEET: 22



Public Works

OATES DR NORTH (5) - SIDEWALKS



MANAMAN A





DRIVEWAY/ STREET APRON


5' WIDE CONCRETE SIDEWALK

BLOCK SODDING



CURB RAMP

FENCELINE

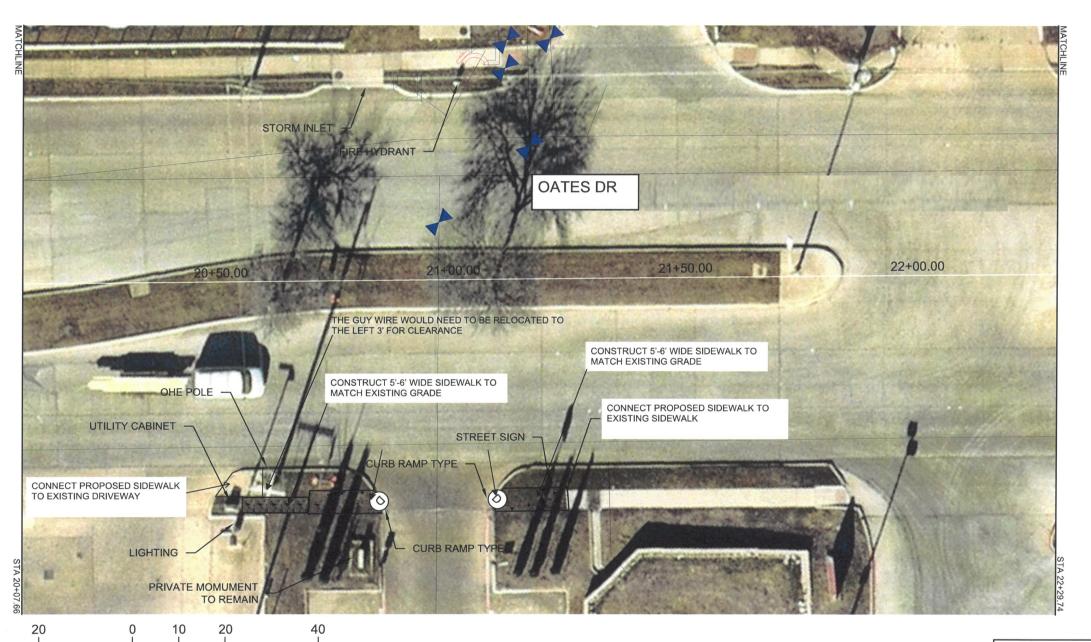

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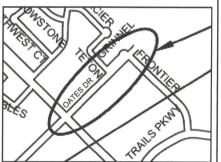
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PROJECT LOCATION



CDBG 2023 SIDEWALK IMPROVEMENT PROJECT CITY CONTRACT #2023-008

SCALE - 1" = 20'

REVISIONS

DATE 2/17/2023 SHEET: 23



Public Works

1 inch = 20 ft.

OATES DR NORTH (6) - SIDEWALKS







LEGEND

DRIVEWAY/ STREET APRON 5' WIDE CONCRETE SIDEWALK



BLOCK SODDING

CURR RAMP



GENERAL NOTES:

- GENERAL NOTES:


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PROJECT LOCATION



CDBG 2023 SIDEWALK IMPROVEMENT PROJECT CITY CONTRACT #2023-008

SCALE - 1" = 20'

DRAWN BY:

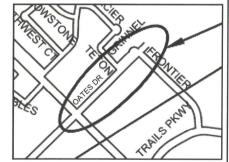REVISIONS

DATE 2/17/2023 **SHEET: 24**



Public Works

1 inch = 20 ft.

OATES DR NORTH (7) - SIDEWALKS







DRIVEWAY/ STREET APRON

5' WIDE CONCRETE SIDEWALK




BLOCK SODDING



CURR RAMP

LEGEND



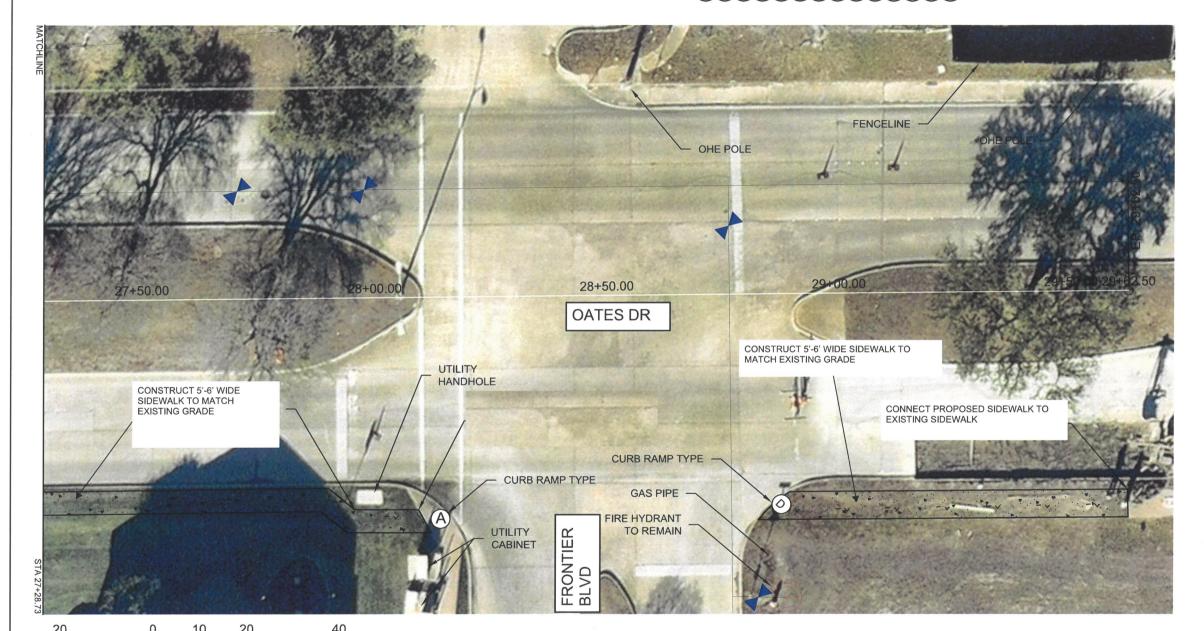

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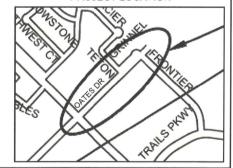
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PROJECT LOCATION



CDBG 2023 SIDEWALK IMPROVEMENT PROJECT CITY CONTRACT #2023-008

SCALE - 1" = 20'

SHEET: 25

REVISIONS

DATE 2/17/2023

MESQUITE T E X A S Real. Texas. Service.

Public Works

1 inch = 20 ft.

OATES DR NORTH (8) - SIDEWALKS









5' CONCRETE SIDEWALK

- STOP SIGN

- FIRE HYDRANT - MANHOLE COVER

SEWER MANHOLE COVER

GAS METER

W - WATER METER

O - OVER HEAD UTILITY POLE

- OVER HEAD UTILITY POLE

- UTILITY POLE W/ STREET LIGHT -STREET LIGHT

NEW CURB RAMP

ER - EMERGENCY NOTIFICATION SPEAKER

- TRAFFIC SIGNAL

GENERAL NOTES:

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 AT LEAST 48 HOURS PRIOR TO BEGINNING CONSTRUCTION.
 ANY VERTICAL ELEVATIONS SHOWN ON PLANS ARE BASED ON THE NAVD83
 NETWORK.

PROJECT NOTES:

- 1. CONSTRUCT NEW 5' WIDE SIDEWALK (6' WIDE AGAINST BACK OF CURB)
- 2. INSTALL A.D.A. COMPLIANT RAMPS AT LOCATIONS SHOWN. REFER TO DESIGN DETAIL SHEET
- 3. TIE NEW SIDEWALK TO EXISTING SIDEWALK OR OTHER EXISTING CONNECTION POINTS AS SHOWN AND REQUIRED
- 4. REMOVE AND REPLACE DRIVEWAY, REFER TO MESQUITE DESIGN DETAIL SHEET

PROJECT LOCATION



CDBG 2023 SIDEWALK IMPROVEMENT PROJECT CITY CONTRACT #2023-008

SCALE - 1" = 40'

DRAWN BY:

REVISIONS

2/17/2023

SHEET: 26



Public Works

DRIFTWOOD DR - SIDEWALKS

DRIFTWOOD DR STA 01+59

(1)(4) SIDEWALK SECTION LENGTH 18 LF

END DRIFTWOOD DR STA 01+85

NORTHING = 6983964.39 EASTING = 2540719.29

NORTHING = 6983951.37 EASTING = 2540694.02

BEGIN DRIFTWOOD DR STA 00+18 NORTHING = 6983891.21 EASTING = 2540570.85

-3/4/ SIDEWALK SECTION

LENGTH 133 LF

DRIFTWOOD DR

REF MESQUITE STANDARD DETAIL P-18.



BEGIN OATES DRIVE STA 0+78

NORTHING = 6987910 70

EASTING = 2538281.64



OATES DRIVE STA 1+18 NORTHING = 6987943.14 DRIVE EASEMENT 26 SY OATES DRIVE STA 2+98 NORTHING = 6988067.81 OATES DRIVE STA 1+20 EASTING = 2538434.24 REF MESQUITE STANDARD NORTHING = 6987941.57 EASTING = 2538312.60 OATES DRIVE STA 1+13 REF MESQUITE STANDARD DETAIL P-19. SIDEWALK SECTION LENGTH 135 LF NORTHING = 6987938.97 EASTING = 2538305.83 DRIVE EASEMENT 20 SY REF MESQUITE STANDARD REF MESQUITE STANDARD
DETAIL SHEET P-19. OATES DRIVE STA 1+31 OATES DRIVE STA 2+58 DETAIL P-19. NORTHING = 6987949.93 NORTHING = 6988040.90 REF MESQUITE STANDARD EASTING = 2538317.56 EASTING = 2538406.56 DETAIL P-19. SIDEWALK SECTION SIDEWALK SECTION LENGTH 127 LF LENGTH 45 LF TO REF MESQUITE STANDARD MATCHLINE DETAIL P-19.



LEGEND

- GAS METER

- WATER METER - OVER HEAD UTILITY POLE

- OVER HEAD UTILITY POLE - UTILITY POLE W/ STREET LIGHT

- STREET LIGHT

NEW CURB RAMP

ER - EMERGENCY NOTIFICATION SPEAKER

- TRAFFIC SIGNAL

GENERAL NOTES:

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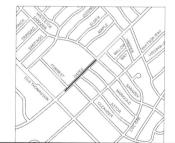
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PROJECT LOCATION



OATES DRIVE: 1" = 40'



Public Works SCALE - 1" = 40'

NORTHING = 6988164.27 EASTING = 2538517.63


OATES DRIVE (1) - SIDEWALKS


OATES DR

SIDEWALK IMPROVEMENT PROJECT CITY CONTRACT #2023-008 DRAWN BY:

REVISIONS

2/17/2023

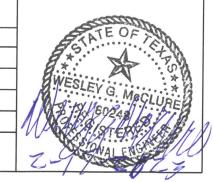

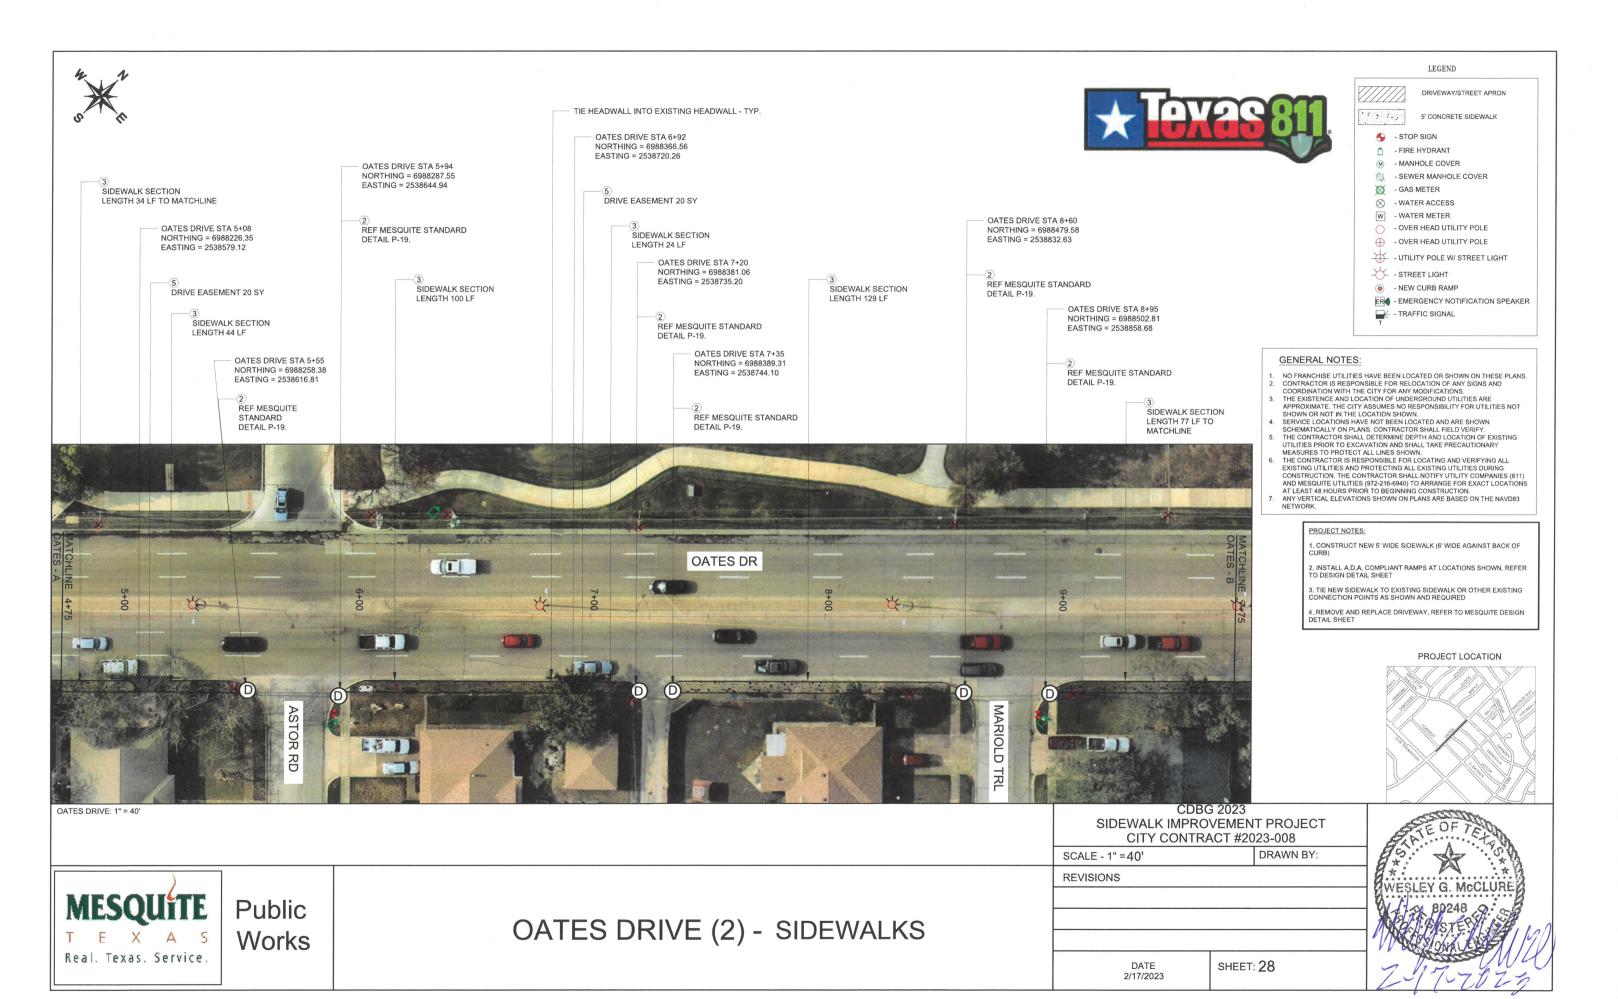



SIDEWALK SECTION LENGTH 49 LF TO MATCHLINE

> OATES DRIVE STA 10+20 NORTHING = 6988301.37 EASTING = 2538945.52

REF MESQUITE STANDARD DETAIL P-19.

OATES DRIVE STA 10+35 NORTHING = 6988226.35 EASTING = 2538945.52

REF MESQUITE STANDARD DETAIL P-19.

SIDEWALK SECTION

END OATES DRIVE STA 11+59 NORTHING = 6988697.19 EASTING = 2539045.87



OATES DRIVE: 1" = 40'



Public Works

OATES DRIVE (3) - SIDEWALKS





5' CONCRETE SIDEWALK

- STOP SIGN - FIRE HYDRANT

- MANHOLE COVER

SEWER MANHOLE COVER

GAS METER

W - WATER METER

- OVER HEAD UTILITY POLE

- OVER HEAD UTILITY POLE

- UTILITY POLE W/ STREET LIGHT

- STREET LIGHT

NEW CURB RAMP

ER ← - EMERGENCY NOTIFICATION SPEAKER

- TRAFFIC SIGNAL

GENERAL NOTES:

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PROJECT LOCATION




CDBG 2023	
SIDEWALK IMPROVEMENT	PROJEC
CITY CONTRACT #202	23-008

SCALE - 1" = 40"

DRAWN BY:

REVISIONS

2/17/2023

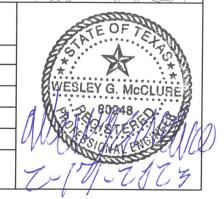





POTTER LANE STA 3+71 NORTHING = 6961788.75

EASTING = 2543346.15

SIDEWALK SECTION LENGTH 65 LF TO MATCHLINE LEGEND

DRIVEWAY/STREET APRON

8' CONCRETE SIDEWALK

- FIRE HYDRANT

- MANHOLE COVER

- SEWER MANHOLE COVER

- GAS METER

W - WATER METER

- OVER HEAD UTILITY POLE

- OVER HEAD UTILITY POLE

- UTILITY POLE W/ STREET LIGHT

- STREET LIGHT

NEW CURB RAMP

ER - EMERGENCY NOTIFICATION SPEAKER

- TRAFFIC SIGNAL

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PROJECT LOCATION



CDBG 2023 SIDEWALK IMPROVEMENT PROJECT CITY CONTRACT #2023-008

SCALE - 1" = 40'

REVISIONS



Public Works

BEGIN POTTER LANE STA 0+30

SIDEWALK SECTION LENGTH 23 LF

NORTHING = 6961785.93

EASTING = 2,543,005.79

TIE HEADWALL INTO EXISTING HEADWALL - TYP.

POTTER LANE STA 1+33

NORTHING = 6961784.02 EASTING = 2543108.22

DRIVE EASEMENT 31SY

SIDEWALK SECTION LENGTH

POTTER LANE (1) - SIDEWALKS (PEACHTREE TO ERWIN 1)

POTTER LANE STA 2+19

NORTHING = 6961784.32 EASTING = 2543192.50

DRIVE EASEMENT 32 SY

SIDEWALK SECTION LENGTH 56 LF

SIDEWALK SECTION LENGTH 74 LF

POTTER LANE STA 2+95 NORTHING = 6961786.93 EASTING = 2543256.70

DRIVE EASEMENT 37 SY

POTTER LN

DATE 2/17/2023

DRAWN BY: **SHEET:** 30



SIDEWALK SECTION LENGTH 81 LF TO MATCHLINE

TIE HEADWALL INTO EXISTING HEADWALL - TYP. POTTER LANE STA 6+22 DRIVE EASEMENT 31 SY EASTING = 2543610.57 SIDEWALK SECTION LENGTH 45 LF DRIVE EASEMENT 31 SY POTTER LANE STA 7+50 -NORTHING = 6961796.68 EASTING = 2543729.49 POTTER LANE STA 8+22 NORTHING = 6961797.98 EASTING = 2543782.88 SIDEWALK SECTION LENGTH 107 LF DRIVE EASEMENT 32 SY SIDEWALK SECTION LENGTH 14 LF STANDARD DETAIL P-19.



SIDEWALK SECTION

POTTER LANE: 1" = 40'



Public Works POTTER LANE (2) - SIDEWALKS (PEACHTREE TO ERWIN 2)



LEGEND



DRIVEWAY/STREET APRON

8' CONCRETE SIDEWALK

- STOP SIGN

- FIRE HYDRANT

- MANHOLE COVER

- SEWER MANHOLE COVER GAS METER

W - WATER METER

- OVER HEAD UTILITY POLE

- OVER HEAD UTILITY POLE

- UTILITY POLE W/ STREET LIGHT - STREET LIGHT

NEW CURB RAMP

ER - EMERGENCY NOTIFICATION SPEAKER

- TRAFFIC SIGNAL

GENERAL NOTES:

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PROJECT LOCATION



CDBG 2023
SIDEWALK IMPROVEMENT PROJECT
CITY CONTRACT #2023-008


SCALE - 1" =40'


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REVISIONS


REF MESQUITE

DATE



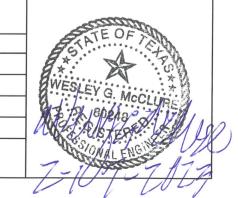

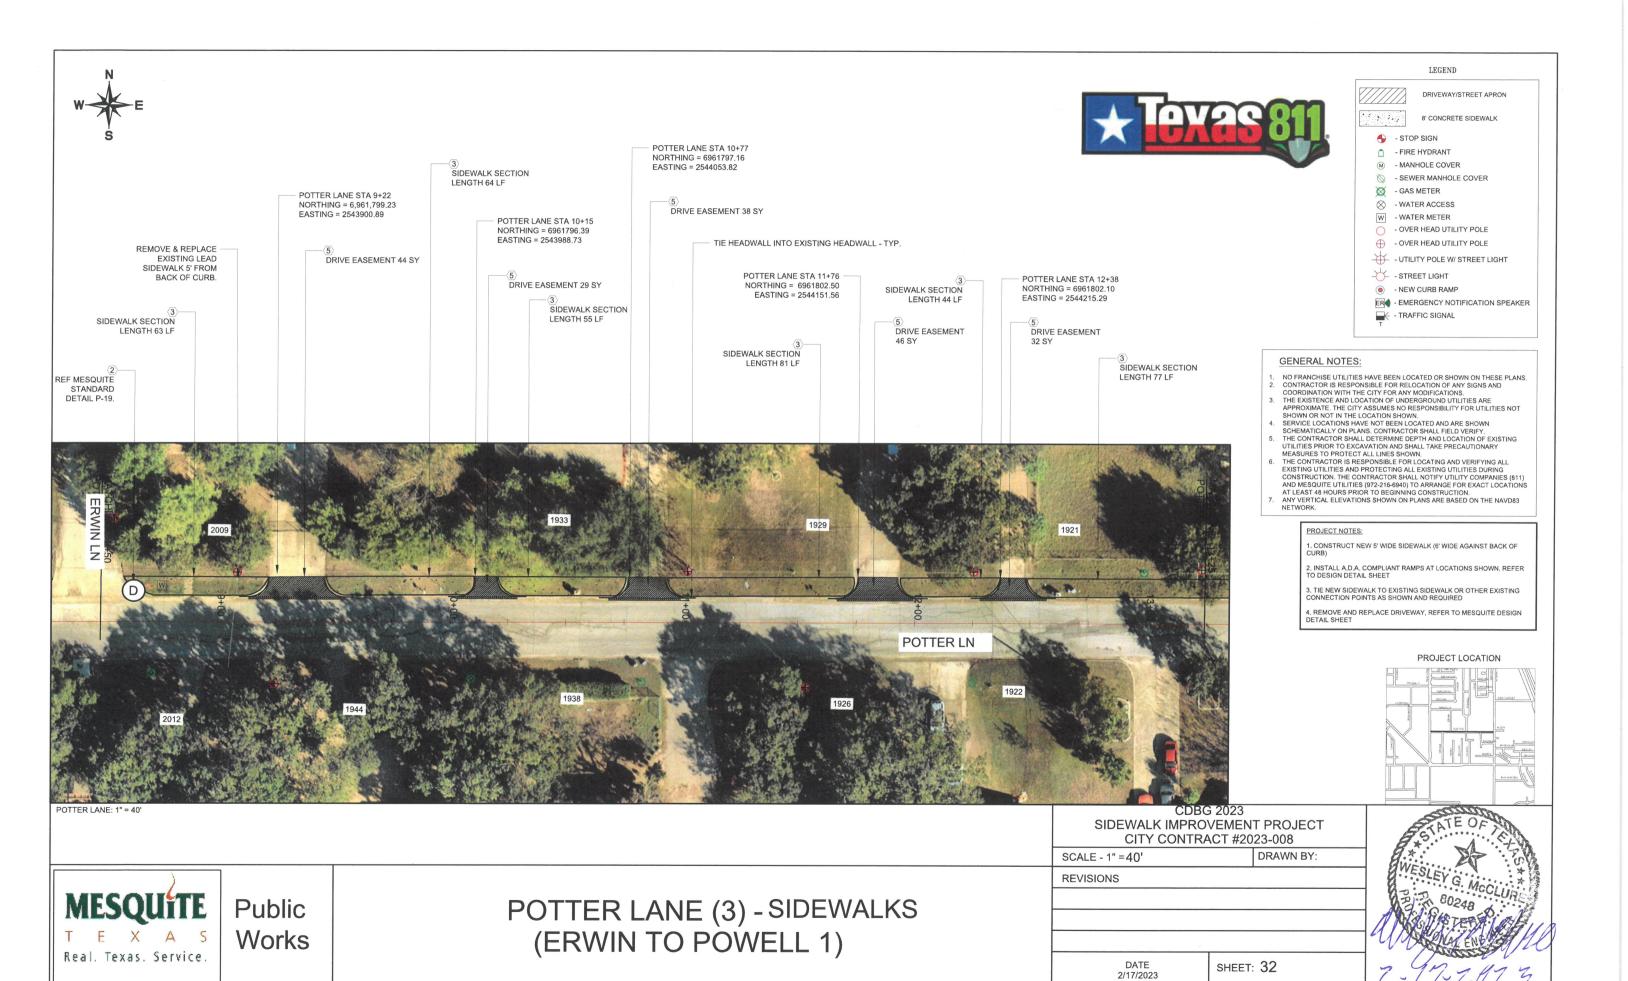

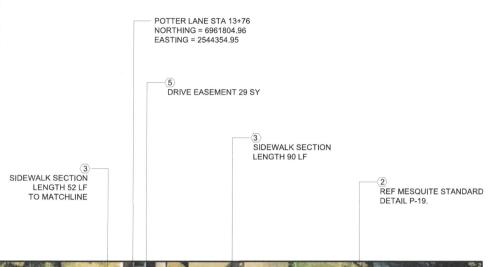



POTTER LANE: 1" = 40'



Public Works

POTTER LANE (4) - SIDEWALKS (ERWIN TO POWELL 2)

LEGEND

DRIVEWAY/STREET APRON 8' CONCRETE SIDEWALK

- STOP SIGN

- FIRE HYDRANT

M - MANHOLE COVER

> - SEWER MANHOLE COVER

GAS METER

- WATER ACCESS

W - WATER METER

- OVER HEAD UTILITY POLE

- OVER HEAD UTILITY POLE

- UTILITY POLE W/ STREET LIGHT



ER - EMERGENCY NOTIFICATION SPEAKER



- TRAFFIC SIGNAL

GENERAL NOTES:

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 2. CONTRACTOR IS RESPONSIBLE FOR RELOCATION OF ANY SIGNS AND
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 NETWORK.

PROJECT NOTES:

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PROJECT LOCATION




CDBG 2023 SIDEWALK IMPROVEMENT PROJECT CITY CONTRACT #2023-008			T
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CDBG 2023	SID	EWALK IMPROVEME	ENT PROJECT
		CDBG 2023	3


SCALE - 1" =40'

DRAWN BY:

REVISIONS

DATE 2/17/2023

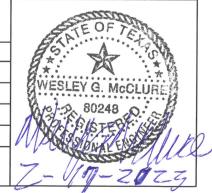

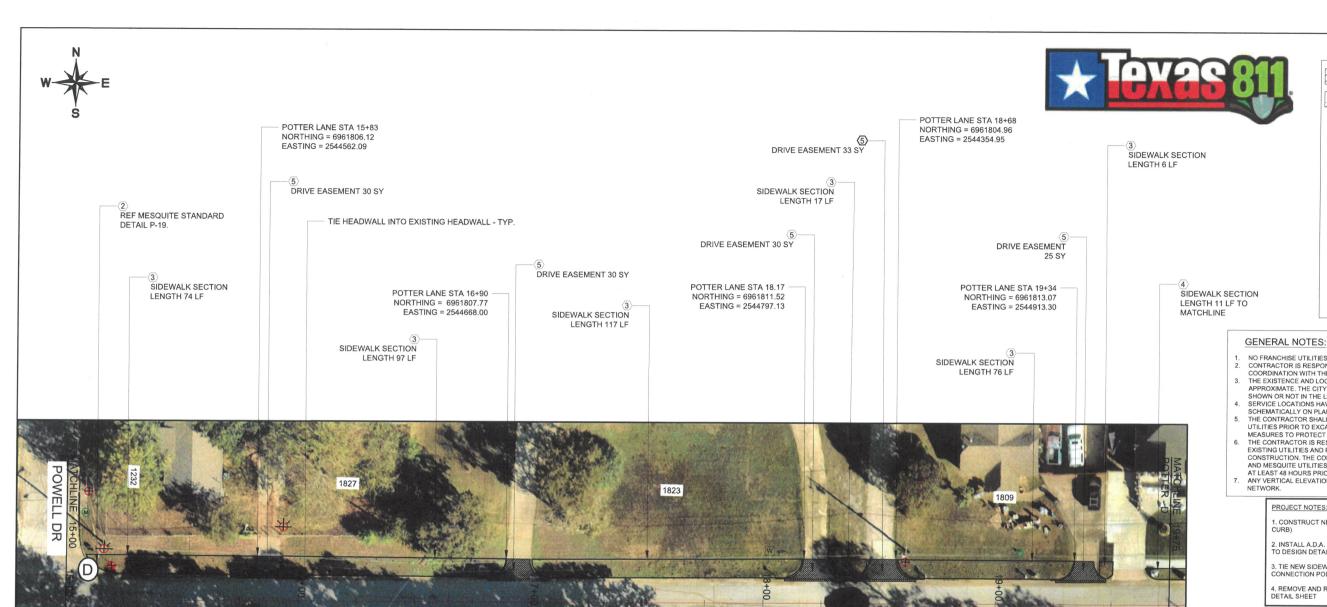

LEGEND

DRIVEWAY/STREET APRON

8' CONCRETE SIDEWALK

- STOP SIGN

- FIRE HYDRANT

- MANHOLE COVER - SEWER MANHOLE COVER

- GAS METER

- WATER ACCESS

W - WATER METER

- OVER HEAD UTILITY POLE

- OVER HEAD UTILITY POLE

- UTILITY POLE W/ STREET LIGHT

-STREET LIGHT

NEW CURB RAMP

ER - EMERGENCY NOTIFICATION SPEAKER

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PROJECT LOCATION



SIDEWALK IMPROVEMENT PROJECT CITY CONTRACT #2023-008

SCALE - 1" = 40'

DRAWN BY:

REVISIONS

2/17/2023

SHEET: 34

MESQUITE T E X A S Real. Texas. Service.

POTTER LANE: 1" = 40'

Public Works POTTER LANE (5) -SIDEWALKS (POWELL TO RODEO CTR BLVD 1)



4\7\ SIDEWALK SECTION

SIDEWALK SECTION LENGTH 20 LF

POTTER LANE STA 20+59

DRIVE EASEMENT 32 SY

SIDEWALK SECTION

LENGTH 63 LF

NORTHING = 6961815.65 EASTING = 2545037.49

LENGTH 50 LF TO

MATCHLINE



LEGEND



DRIVEWAY/STREET APRON 8' CONCRETE SIDEWALK

- STOP SIGN

- FIRE HYDRANT

- MANHOLE COVER

- SEWER MANHOLE COVER

W - WATER METER

- OVER HEAD UTILITY POLE

- OVER HEAD UTILITY POLE

- UTILITY POLE W/ STREET LIGHT

- STREET LIGHT

NEW CURB RAMP

ER - EMERGENCY NOTIFICATION SPEAKER

- TRAFFIC SIGNAL

SIDEWALK SECTION LENGTH 26 LF TO MATCHLINE

DRIVE EASEMENT

POTTER LANE STA 24+37

NORTHING = 6961822.01 EASTING = 2545418.28

GENERAL NOTES:

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PROJECT LOCATION



SIDEWALK IMPROVEMENT PROJECT CITY CONTRACT #2023-008

SCALE - 1" =40'

DRAWN BY:

REVISIONS

DATE 2/17/2023

SHEET: 35

MESQUITE T E X A S Real. Texas. Service.

Public Works

POTTER LANE (6) - SIDEWALKS (POWELL TO RODEO CTR BLVD 2)

POTTER LANE STA 21+35

DRIVE EASEMENT 32 SY

SIDEWALK SECTION

TIE HEADWALL INTO EXISTING HEADWALL - TYP.

DRIVE EASEMENT 38 SY

REMOVE & REPLACE

SIDEWALK 8' FROM BACK OF CURB

EXISTING LEAD

POTTER LANE STA 21+89

EASTING = 2545169.16


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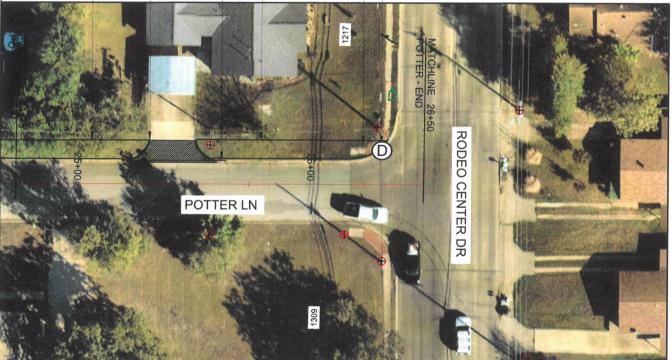
EASTING = 2545113.45

POTTER LN

SIDEWALK SECTION





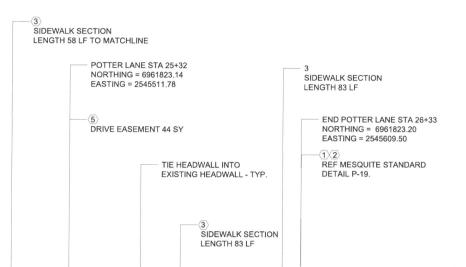



Public Works

POTTER LANE (7) - SIDEWALKS (POWELL TO RODEO CTR BLVD 3)

LEGEND



DRIVEWAY/STREET APRON



8' CONCRETE SIDEWALK



- FIRE HYDRANT

M - MANHOLE COVER

> - SEWER MANHOLE COVER

GAS METER

- WATER ACCESS

W - WATER METER

- OVER HEAD UTILITY POLE

- OVER HEAD UTILITY POLE

- UTILITY POLE W/ STREET LIGHT

-STREET LIGHT

NEW CURB RAMP

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- TRAFFIC SIGNAL

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- APPROXIMATE. THE CITY ASSUMES NO RESPONSIBILITY FOR UTILITIES NOT SHOWN OR NOT IN THE LOCATION SHOWN.

 SERVICE LOCATIONS HAVE NOT BEEN LOCATED AND ARE SHOWN SCHEMATICALLY ON PLANS. CONTRACTOR SHALL FIELD VERIFY. THE CONTRACTOR SHALL DETERMINE DEPTH AND LOCATION OF EXISTING UTILITIES PRIOR TO EXCAVATION AND SHALL TAKE PRECAUTIONARY MEASURES TO PROTECT ALL LINES SHOWN.

 THE CONTRACTOR IS RESPONSIBLE FOR LOCATING AND VERIFYING ALL EXISTING UTILITIES AND PROTECTING ALL EXISTING UTILITIES DURING CONSTRUCTION. THE CONTRACTOR SHALL NOTIFY UTILITY COMPANIES (811) AND MESQUITE UTILITIES (972-216-6940) TO ARRANGE FOR EXACT LOCATIONS AT LEAST 48 HOURS PRIOR TO BEGINNING CONSTRUCTION.
- ANY VERTICAL ELEVATIONS SHOWN ON PLANS ARE BASED ON THE NAVD83 NETWORK.

PROJECT NOTES:

- 1. CONSTRUCT NEW 5' WIDE SIDEWALK (6' WIDE AGAINST BACK OF
- 2. INSTALL A.D.A. COMPLIANT RAMPS AT LOCATIONS SHOWN, REFER TO DESIGN DETAIL SHEET
- 3. TIE NEW SIDEWALK TO EXISTING SIDEWALK OR OTHER EXISTING CONNECTION POINTS AS SHOWN AND REQUIRED
- 4. REMOVE AND REPLACE DRIVEWAY, REFER TO MESQUITE DESIGN DETAIL SHEET

PROJECT LOCATION



CDBG 2023 SIDEWALK IMPROVEMENT PROJECT CITY CONTRACT #2023-008


SCALE - 1" = 40'

DRAWN BY:

REVISIONS

DATE

2/17/2023

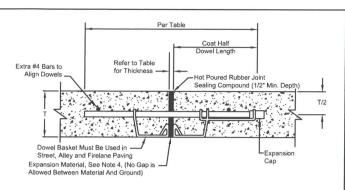


EXPANSION JOINT


	Smooth D	Dowel Bars								
Commercial Driveway, Street, Alley & Firelane Paving Thickness (In.)	Diameter (in.)	Length (in.)	Spacing (in.)	Expansion Joint Thickness						
6	#8 (1 ln.)	30	18	3/4"						
> 6 and ≤ 12	#11 (1.4 in.)	30	12	3/4"						
> 12	Determined by City Engineer									
Sidewalk, Residential Driveway and Trail Thickness (in.)	Diameter (in.)	Length (in.)	Spacing (in.)	Expansion Joint Thickness						
4-6	#4 (1/2 in.)	24	12	1/2"						


NOTES

- Expansion Cap for Dowels Shall have an Inside Diameter of 1/16" Greater than that of Dowel and be Designed to Provide Free Movement of the Dowel Bar.
- 2. Expansion Cap to Fit Dowel Min. 2" Embedment and Min. 1-1/4" Clearance from the Closed End of the Sleeve to the Dowel
- Expansion Joints Shall be Installed at a Maximum Distance of Six Hundred (600) Feet, and at Street Intersections Radii, PC's and PT's or as Otherwise Directed. No Expansion Joint Shall fall in a Driveway Approach or Inlet.
- Expansion Material Per Approved Material List



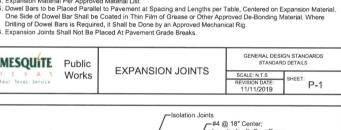

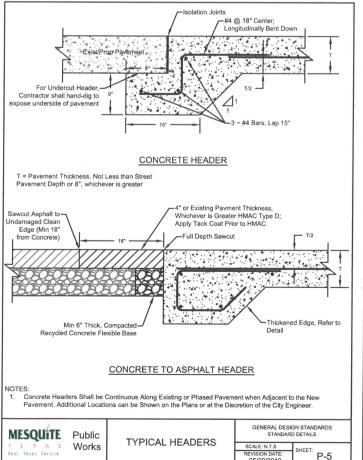

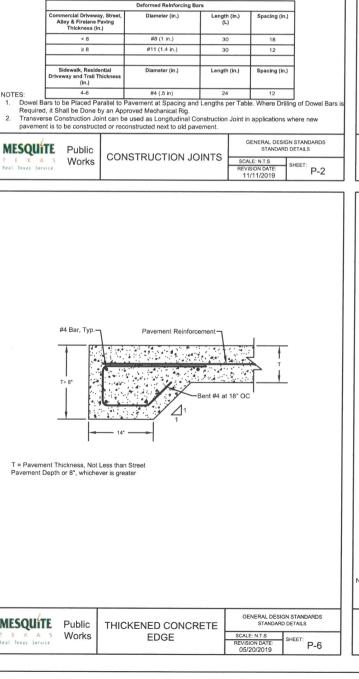

Vertical Saw-cut 1/4" Wide (Min.). Filled w/Hot Poured Rubber Joint Sealing Compound)

Vertical Saw-cut 1/4" Wide (Min.). Filled w/Ho

oured Rubber Joint Sealing C

T/4 or 2" Whichever is les

LONGITUDINAL CONSTRUCTION JOINT


Deformed Reinforcing Bar-


TRANSVERSE CONSTRUCTION JOINT

Keyway Required for Handnou


Diameters & Tie


T = Pavement Thickness

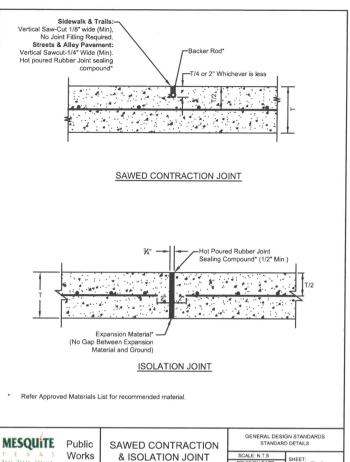

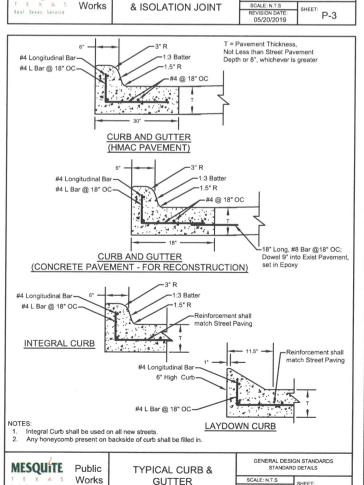

P-7

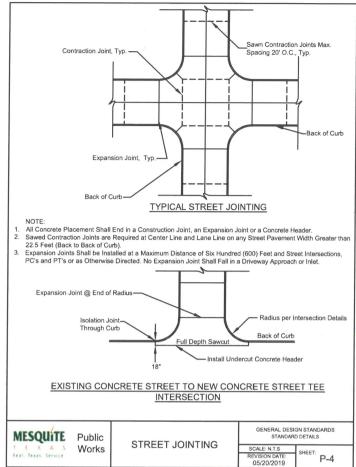

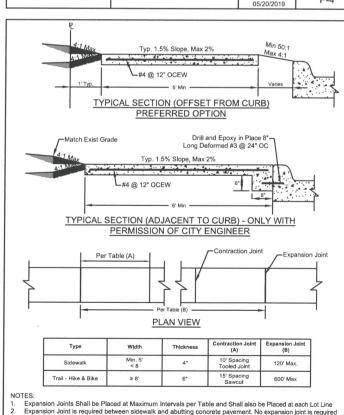




GENERAL DESIGN STANDARDS STANDARD DETAILS MESQUITE Public PEDESTRIAN FACILITIES Works





MESQUÍTE

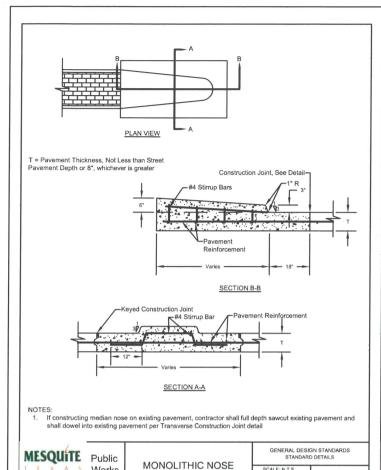


Works


Real Texas Service

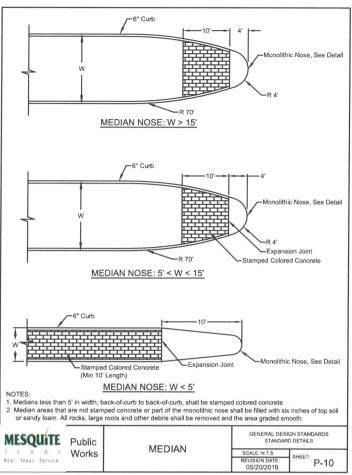


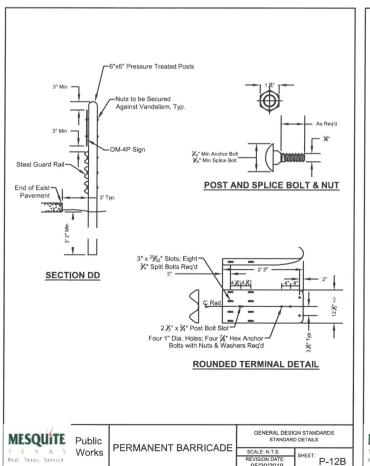


P-9

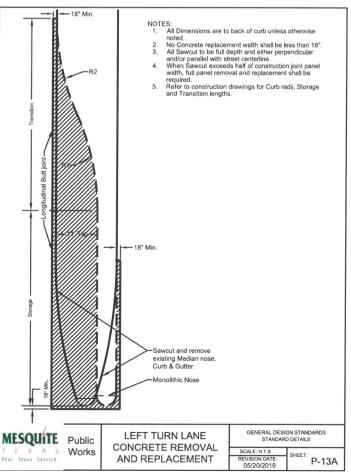

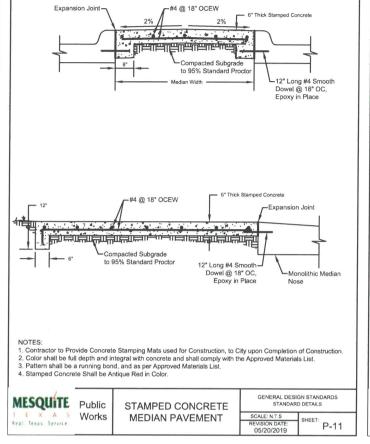

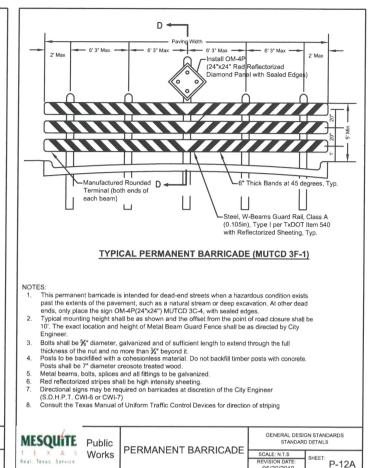

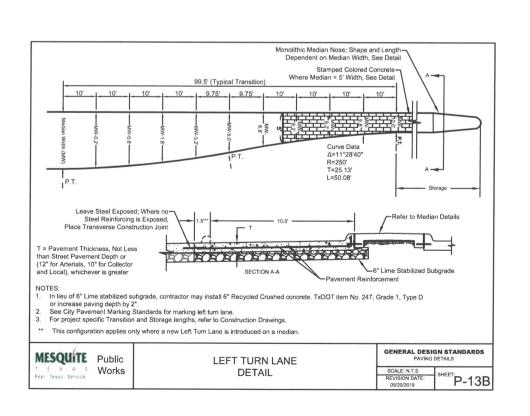


CITY OF MESQUITE, TEXAS PUBLIC WORKS DEPARTMENT STANDARD DETAILS

MESQUITE

T E X A S

Real. Texas. Service.

Taper Curb.

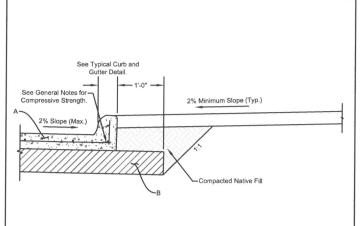

Classification	Minimum Pavement Thickness (A)	Minimum Subgrade Thickness (B)	Minimum Bar: Maximum Spacing Reinforcing Steel							
Local	6"	6" Lime Stabilized at 8% (Or 6" Crushed Concrete)	#4 @ 18" C.C.							
Collector	8"	8" Lime Stabilized at 8% (Or 8" Crushed Concrete)	#4 @ 18" C.C.							
Fire Lane		Per Fire Lane Detail	e Lane Detail							
Alleys	Per Typical Alley Detail Per Engineering Design Manual Section 2.11 #4 @ 18" C.C.									
Arterials										

Crushed concrete shall meet TXDOT specifications, Item 247, Type D. Grade 1 or 2 with Triax TX 140 Geogrid (or approved equal)


MESQUITE Public Works E X A S

MESQUITE Public

A 5 Works

CONCRETE PAVEMENT DETAIL TYPICAL SECTION

GENERAL DESIGN STANDARDS STANDARD DETAILS

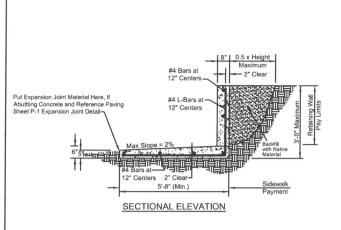


- 1. Exposed face or wall shall have form liner Sika Greenstreak #439 Sierra Drystack or Symons #F3170575 /#F3170503 Standard Dry Stack or as directed by the City Engineer. Form liner is required for walls 6-inches in height and over.
- Minimum compressive design strength of the concrete shall be 4,000psi at 28 days, 6 sack minimum cement content.
- 3. Minimum grade of reinforcing steel is to be ASTM A615 grade 60.
 4. All distances to reinforcing steel refer to clear concrete cover over reinforcing steel unless noted otherwise.
- 5. Minimum reinforcing steel lap is to be thirty (30) bar diameters.
 6. Maximum spacing of expansion joints shall be 120-feet. An expansion joint shall be placed at each property line. Expansion joints shall be continuous through wall and associated sidewalk. All exposed edges shall have a 3/4 inch chamfer.
- Sidewalk width shown is minimum width. Consult paving plans for the clear sidewalk width.

MESQUITE Public

CONCRETE SIDEWALK Works WITH RETAINING WALL

SHEET: P-19

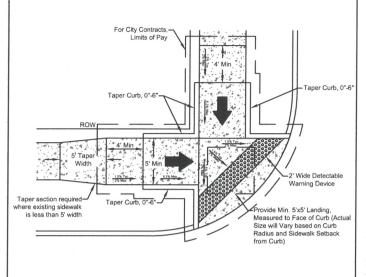

- All pedestrian elements, including curb ramps, shall comply with the Proposed Accessibility Guidelines for Pedestrian Facilities in the Public Right-of-Way (PROWAG), published by the Architectural and Transportation Compliance Board on July 26, 20111, 36 CFR Part 1190 or its final adopted guidelines. All pedestrian paths shall have typical 1.5%, maximum 26' cross slope. Detail are representation of information from PROWAG and are intended to provide guidance. It is the
- responsibility of the Design Professional and the Contractor to ensure that all ramps constructed meet the requirements of PROWAG.

2. Where a Curb is Used, the Required Clearance Shall be Measured from the Curb Face to any Permanent

Concrete Shall be 4000 psi at 28 Days, 6 Sack Mix Minimum. Refer to Paving General Notes for Additional Requirements.
 C" Lime Stabilized Subgrade may be Substituted by Either Additional 2" of Concrete paving or 6"

6" Lime Stabilized Subgrade may be Substituted by Either Additional 2" of Concrete paving or 6"
Recycled Concrete Flexible Base (For TXDOT Item 247, Grade 1, Type D).
 All Dimensions are Face to face of Curb. Where a fire lane dead ends and exceeds 150' length, a harmerhead or cul-de-sac per detail P-14b must be provided for the fire truck to turn around.
 For Fire Lane Pavement width, refer to 2015 International Fire Code Appendix D 103 and City Ordinances 4486 and 4499 for amendments.

MESQUITE Public Works

CURB RAMP TYPE A

1. Refer to Detail for Expansion Joint and Contraction Joint, for Spacing, etc. of Joints

GENERAL DESIGN STANDARDS STANDARD DETAILS P-16 05/20/2019

MESQUITE Public Works

CURB RAMP TYPE B

All pedestrian elements, including curb ramps, shall comply with the Proposed Accessibility Guidelines for Pedestrian Facilities in the Public Right-of-Way (PROWAG), published by the Architectural and Transportation Compliance Board on July 26, 20111, 36 CFR Part 1190 or its final adopted guidelines.

All pedestrian paths shall have typical 1.5%, maximum 2% cross slope.

Detail are representation of information from PROWAG and are intended to provide guidance. It is the responsibility of the Design Professional and the Contractor to ensure that all ramps constructed meet the requirements of PROWAG.

Pay Limits for Curb Ramp-

Provide Min. 4'x4' Landing,-

where existing sidewall

Taper Curb 0"-6"

is less than 5' width


Measured to Face of Curb (Actua Size will Vary based on Curb Radius and Sidewalk Setback

from Curb); Landing shall be entirely within striped crosswalk area. Typ

ROW

GENERAL DESIGN STANDARDS STANDARD DETAILS P-17


Warning Device

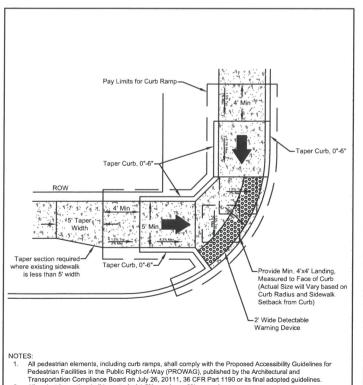

All pedestrian paths shall have typical 1.5%, maximum 2% cross slope. Detail are representation of information from PROWAG and are intended to provide guidance. It is the responsibility of the Design Professional and the Contractor to ensure that all ramps constructed meet the requirements of PROWAG.

CURB RAMP

TYPE C

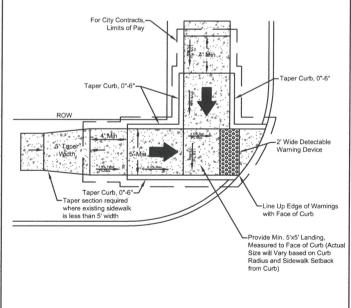


GENERAL DESIGN STANDARDS


P-18

- All pedestrian elements, including curb ramps, shall comply with the Proposed Accessibility Guidelines for Pedestrian Facilities in the Public Right-of-Way (PROWAG), published by the Architectural and Transportation Compliance Board on July 26, 20111, 36 CFR Part 1190 or its final adopted guidelines.
- All pedestrian paths shall have typical 1.5%, maximum 2% cross slope.

 Detail are representation of information from PROWAG and are intended to provide guidance. It is the responsibility of the Design Professional and the Contractor to ensure that all ramps constructed meet the requirements of PROWAG.

MESQUITE	Public	CURB RAMP	GENERAL DESI STANDARI	
TEXAS	Works	TYPE D	SCALE: N.T.S	SHEET:
Real Texas Service.		11125	REVISION DATE:	D_10

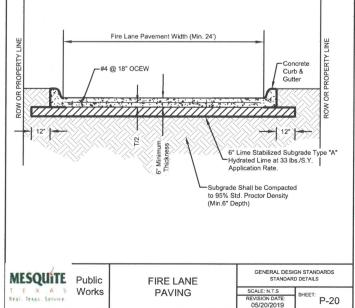

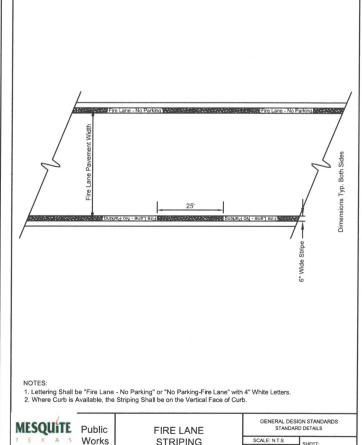

STRIPING 05/20/2019 CITY OF MESQUITE, TEXAS PUBLIC WORKS DEPARTMEN STANDARD DETAILS MESQUITE

T E × A S

Real. Texas. Service.


P-21

CITY OF MESQUITE, TEXAS PUBLIC WORKS DEPARTMENT STANDARD DETAILS

MESQUÍTE

T E × A S

Real. Texas. Service.

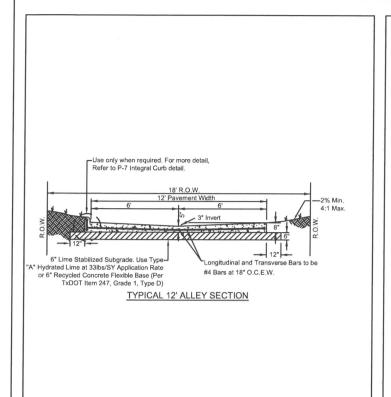




- . On residential driveways, in lieu of 18" blockout into street, contractor may horizontally sawcut curb. On
- commercial driveways, use full-depth sawcut 18" from face of curb.

 For driveway with and curb radii, refer to Section 2 of Design Manual. Residential driveway shall be a minimum of wide and maximum 24" wide. If residential property has three enclosed garages, maximum driveway width can be 30". Driveways must still be in compliance with Ordinance in percentage of improved area allowed.
- The flare or radius cannot extend past the extension of the adjoining property line.

 Sidewalk ramps adjacent to commercial driveways must be compliant as per Texas Accessibility Standards (TAS).


 B Draft Proposed Right-of-Way Accessibility Guidelines (PROWAG), as per PROWAG R208.1, where commercial driveways are provided with yield or stop control, detectable warning surfaces should be provided at the junction between the sidewalk and street.
- Expansion Joints are required at the Right-Of-Way/Property line, when connecting to existing concrete driveways
- b. Expansion Joints are required at the Right-Of-Way/Property line, when connecting to existing concrete driveways and at grade breaks on driveway approaches.
 5. Sidewalk through a driveway is to be built to maintain constant cross-slope across the length of the driveway.
 7. The installation of pre-cast concrete paving blocks may be used on driveway approaches as an alternative to the placement of Portland cement concrete and must comply with the same width and thickness specifications required for Portland cement concrete driveway approaches.
 8. Where driveway connections are made to public streets with curbs and gutters; such curb and gutter shall be removed to the nearest construction joint. Design of such connections are to be submitted to the City prior construction.

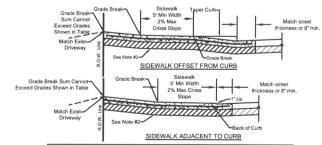



	Residential	Commercial	Industrial					
Concrete Thickness (Minimum)	6"	8" Min.	12"					
Reinforcing (Minimum)	#4 @ 18" OCEW							
Max Slope Connecting to Street	10%	7%	7%					
Max Slope Connecting to Alley	14%	11%	11%					
Flare/Radius	5' Min.	By Ordinance	By Ordinance					


DRIVEWAY PARAMETERS


GENERAL DESIGN STANDARDS STANDARD DETAILS **MESQUITE** Public DRIVEWAY Works P-26

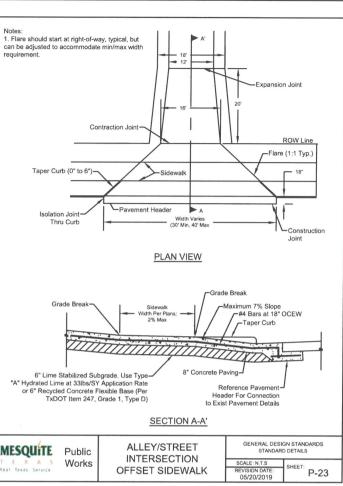


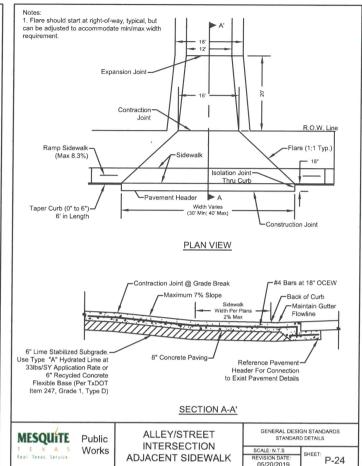

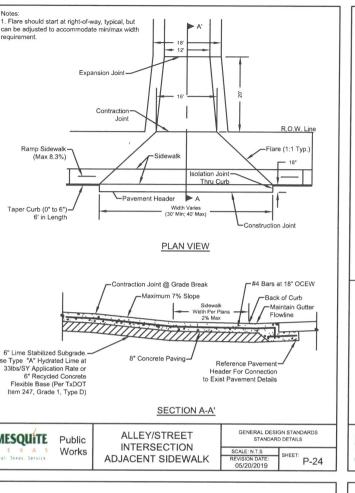

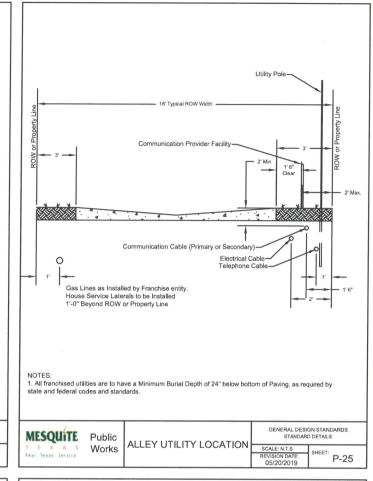

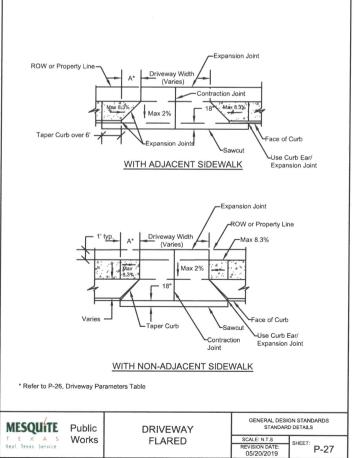

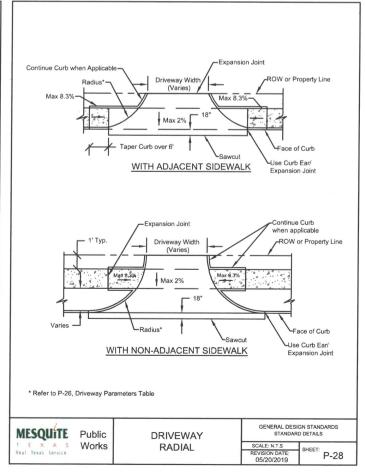



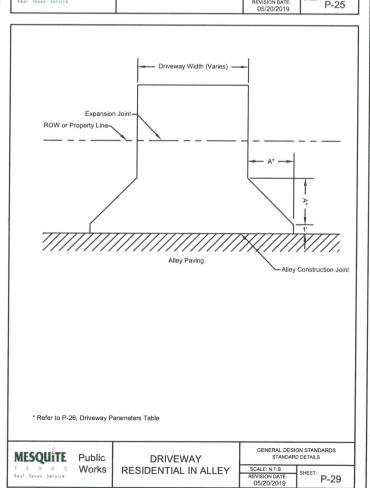


TABLE OF VARIABLE DIMENSIONS (5)


	1	AND		ITIES			VSION IEADV	
	e	Pipe		for One	Pipe	Values for Eac	To Be A h Addt'l	dded Pipe
	Slope	Dia of (D)	w	Reinf (Lbs)	Conc (CY)	W	Reinf (Lbs)	Cond (CY)
		12"	9' - 0''	122	1.1	1' - 9''	15	0.2
		15"	10' - 3"	136	1.3	2' - 2"	16	0.2
		18"	11' - 6"	163	1.5	2' - 8''	19	0.3
		21"	12' - 9"	200	1.8	3' - 1"	31	0.4
y sior	1	24"	14' - 0''	217	2.1	3' - 7"	34	0.4
f an nver		27"	15' - 3"	254	2.4	3' - 11"	37	0.5
No warranty of any ility for the convers rom its use.	2:1	30"	16' - 6'' 17' - 9''	272 314	2.7 3.1	4' - 4''	40	0.6
rran r th use	~	36"	19' - 0"	371	3.9	5' - 1"	46	0.8
y fo y fo its		42"	21' - 6"	442	4.9	5' - 10"	52	1.0
. NG ibilit fron		48"	25' - 0"	569	6.4	6' - 7''	59	1.3
Act" oons ing		54"	27' - 6"	701	7.5	7' - 6"	82	1.6
rice resp esult	L	60"	30' - 0''	794	8.8	8' - 3"	90	1.8
no no is re	L	66"	32' - 6"	894	10.2	8' - 9"	96	2.0
as Engineering Practice Act". No warranty of any TXDOT assumes no responsibility for the conversion sults or damages resulting from its use.	⊢	72"	35' - 0"	1,055	11.7	9' - 4"	103	2.3
assu dar	ı	12"	13' - 0"	175	1.6	1' - 9"	14	0.2
ngir 2007 s or		15"	14' - 9'' 16' - 6''	193	1.9	2' - 2"	17	0.2
as E TxE ssult		21"	18' - 3"	228	2.2	2' - 8" 3' - 1"	19 31	0.3
"Tex 'er. ct re		24"	20' - 0"	323	3.0	3' - 7"	33	0.4
the soev		27"	21' - 9"	371	3.5	3' - 11"	37	0.5
by vhat incc		30"	23' - 6"	415	4.0	4' - 4"	40	0.5
DISCLAIMER: The use of this standard is governed by the "Texas Engineering Practice Act". No warrant kind is made by TXODT for any purpose whatsoever. TXDOT assumes no responsibility for the of this standard to other formats or for incorrect results or damages resulting from its use.	3:1	33"	25' - 3"	469	4.6	4' - 8''	43	0.6
gove, urpc s or		36"	27' - 0"	556	5.7	5' - 1"	46	0.8
is g ny p mat		42"	30' - 6"	675	7.1	5' - 10''	52	1.0
dard or a for		48"	35' - 6"	837	9.2	6' - 7''	59	1.3
stanı OT f othe		54" 60"	39' - 0'' 42' - 6''	1,015	11.0	7' - 6" 8' - 3"	91	1.6
his tryD to to		66"	46' - 0"	1,171	14.9	8' - 9"	98	2.0
of t by dard		72"	49' - 6"	1,561	17.1	9' - 4"	103	2.3
DISCLAIMER. The use kind is made of this stand		12"	17' - 0''	229	2.0	1' - 9''	15	0.2
CLAI The is his		15"	19' - 3''	266	2.4	2' - 2"	17	0.2
DIS kind of t		18"	21' - 6"	308	2.9	2' - 8''	19	0.3
		21"	23' - 9"	382	3.5	3' - 1"	31	0.3
		24"	26' - 0"	430	3.9	3' - 7''	34	0.4
		27" 30"	28' - 3" 30' - 6"	486 539	4.7 5.2	3' - 11"	37	0.5
	4:1	33"	32' - 9"	603	6.0	4' - 4''	40	0.6
	4	36"	35' - 0"	738	7.5	5' - 1"	47	0.8
		42"	39' - 6"	881	9.3	5' - 10''	52	1.0
		48"	46' - 0"	1,102	12.1	6' - 7''	61	1.3
		54"	50' - 6"	1,364	14.4	7' - 6"	84	1.6
		60"	55' - 0"	1,547	16.9	8' - 3''	91	1.8
		66"	59' - 6"	1,741	19.5	8' - 9''	98	2.0
	Н	72"	64' - 0"	2,077	22.4	9' - 4''	102	2.3
		12" 15"	25' - 0" 28' - 3"	336 384	3.0 3.6	1' - 9'' 2' - 2''	14	0.2
		18"	31' - 6"	452	4.2	2' - 8"	19	0.2
		21"	34' - 9"	581	5.1	3' - 1"	31	0.4
		24"	38' - 0"	644	5.8	3' - 7"	34	0.4
		27"	41' - 3"	737	6.9	3' - 11"	37	0.5
		30"	44' - 6"	807	7.7	4' - 4''	39	0.6
	6:1	33"	47' - 9"	912	8.9	4' - 8''	44	0.6
		36"	51' - 0"	1,108	11.0	5' - 1''	48	0.8
		42"	57' - 6"	1,318	13.7	5' - 10"	54	1.0
		48" 54"	67' - 0''	1,682	17.9	6' - 7"	59	1.3
		60"	73' - 6" 80' - 0"	2,072 2,351	21.3	7' - 6" 8' - 3"	83 89	1.6
		66"	86' - 6"	2,643	28.9	8' - 9"	96	2.0
		72"	93' - 0"	3,121	33.1	9' - 4"	101	2.3
60.55								

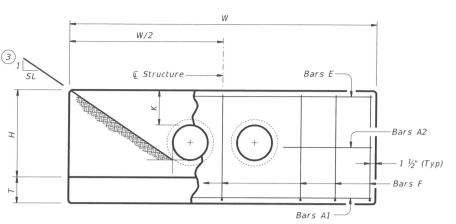

ELEVATION

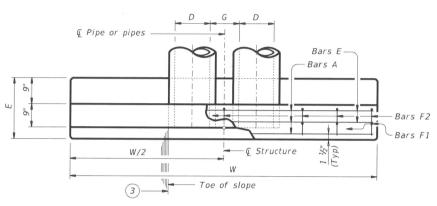

PLAN OF NON-SKEWED PIPES

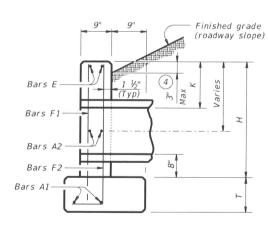

SECTION AT CENTER OF PIPE

TABLE OF CONSTANT DIMENSIONS

Dia of Pipe (D)	G	K (5)	Н	Т	Е
12"	0' - 9''	1' - 0"	2' - 8"	0' - 9"	1' - 9"
15"	0' - 11''	1' - 0"	2' - 11"	0' - 9"	1' - 9"
18"	1' - 2"	1' - 0"	3' - 2"	0' - 9"	1' - 9"
21"	1' - 4"	1' - 0"	3' - 5"	0' - 9"	2' - 0"
24"	1' - 7"	1' - 0"	3' - 8"	0' - 9"	2' - 0"
27"	1' - 8"	1' - 0"	3' - 11"	0' - 9"	2' - 3"
30"	1' - 10''	1' - 0"	4' - 2"	0' - 9"	2' - 3"
33"	1' - 11''	1' - 0"	4' - 5"	0' - 9"	2' - 6"
36"	2' - 1"	1' - 0''	4' - 8"	1' - 0"	2' - 6"
42"	2' - 4"	1' - 0''	5' - 2"	1' - 0"	2' - 9"
48"	2' - 7"	1' - 3"	5' - 11"	1' - 0"	3' - 0"
54"	3' - 0"	1' - 3"	6' - 5"	1' - 0"	3' - 3"
60"	3' - 3"	1' - 3"	6' - 11"	1' - 0"	3' - 6"
66"	3' - 3"	1' - 3"	7' - 5"	1' - 0"	3' - 9"
72"	3' - 4"	1' - 3"	7' - 11"	1' - 0"	4' - 0"

TABLE OF 6 REINFORCING STEEL

Bar	Size	Spa	No.
A1	#5	~	2
A2	#5	1' - 6"	~
Ε	#5	~	2
F	#5	1' - 0"	~

MATERIAL NOTES:

Provide Grade 60 reinforcing steel.

Provide Class C concrete (f'c = 3,600 psi).

GENERAL NOTES:

Designed according to AASHTO LRFD Bridge Design Specifications.

Do not mount bridge rails of any type directly to

these culvert headwalls.

This standard may not be used for wall heights, H, exceeding the values shown.

Cover dimensions are clear dimensions, unless noted otherwise. Reinforcing dimensions are out-to-out of bars.



Bridge Division Standard

CONCRETE HEADWALLS WITH PARALLEL WINGS FOR NON-SKEWED PIPE CULVERTS

CH-PW-0

.E:	chpw0ste-20.dgn	DN: Tx	DOT	CK: TXDOT	DW:	TxDOT	ck: TxD0T
TXDOT	February 2020	CONT	SECT	JOB		Н	IGHWAY
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		DIST		COUNTY SH		SHEET NO.	

1) Total quantities include one 3'-1" lap for bars over 60' in length.

Quantities shown are for concrete pipe and will increase slightly for metal pipe installations.

Indicated slope is perpendicular to centerline pipe or pipes.


For vehicle safety, construct curbs no more than 3" above finished grade. Reduce curb heights, if necessary, to meet these requirements. No changes will be made in quantities and no additional compensation will be allowed for this work.


5 Dimensions shown are usual and maximum.

E - 12"

BARS F2

6 Quantities shown are for one structure end only

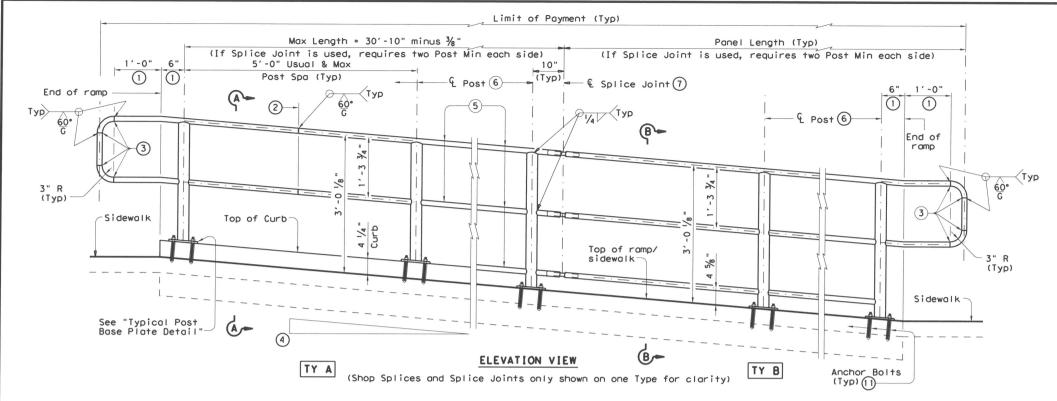

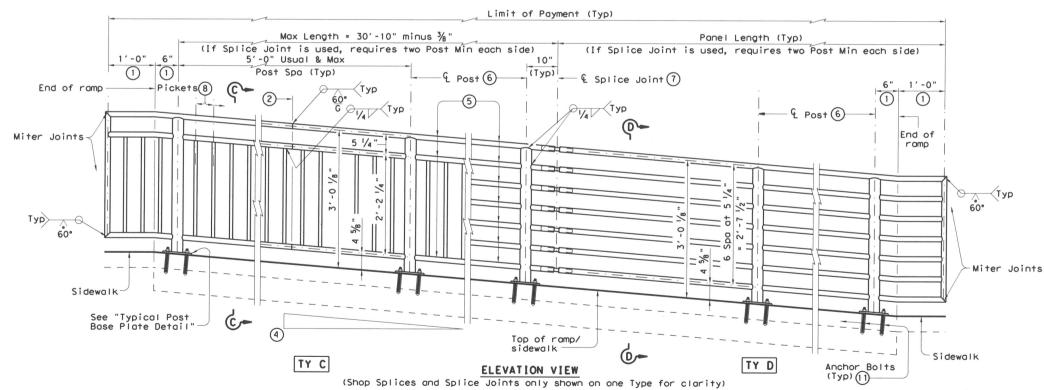

- (1) Parallel to ground.
- ② One shop splice per panel is permitted with minimum 85 percent penetration. The weld may be square groove or single vee groove. Grind smooth.
- (3) Shop splice is permitted with minimum 85 percent penetration. The weld may be square groove or single vee groove. Grind smooth.
- See Romp Details located elsewhere in plans for ramp slope and dimensions. Maximum ramp slope will not exceed 8.3 percent. Level landing required for each 30" rise if grade exceeds 5 percent.
- (5) 1 $\frac{1}{2}$ " Dia. Standard Pipe (1.900" O.D., 0.145" wall thickness). Parallel to ramp / sidewalk. Provide holes as needed in 1 $\frac{1}{2}$ " Dia. pipe for galvanizing drainage and venting.
- 6 2 ½" Dia. Standard Pipe (2.875" O.D., 0.203" wall thickness). See "Post Mount Detail" for crimping and trimming post to fit Dia. of top rail. Provide holes as needed in post for galvanizing drainage and venting. Plumb all posts.
- (7) See "Handrail Fabrication Details" for Splice Joints.
- (8) € %" Dia. Round Bar equal spacing at 4 ½" Max. Plumb all pickets.
- When needed for accessibility (grade > 5 percent) or as needed for pedestrian safety.
- 0 Not to be used on bridges.
- (1) See "General Notes" for anchor bolt information.

RECOMMENDED USAGE 9 10

Dropoff
Height/
Condition

<30"
dropoff


≥ 30"
dropoff,
or along
Bike Path

Dropoff
Recommended Rail Options

Recommended Rail Options

TY A, TY B, TY C, or TY D

TY E or TY F

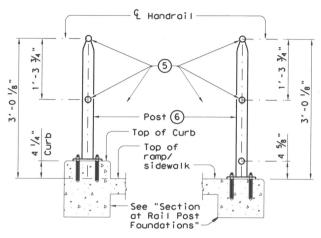


SECTION A-A

(Showing Handrail TY A)

SECTION B-B

(Showing Handrail **TY B**)

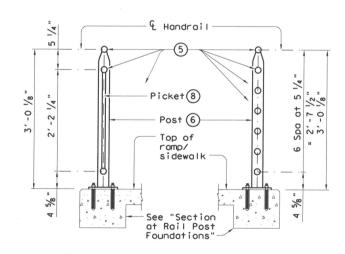

SECTION C-C

(Showing Handrail TY C)

SECTION D-D
(Showing Handrail TY D)

SHEET 1 OF 3

Texas Department of Transportation


Design Division Standard

PEDESTRIAN HANDRAIL DETAILS

PRD-13


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	CONT		CONT SECT JOB	CONT SECT JOB	

ATE:

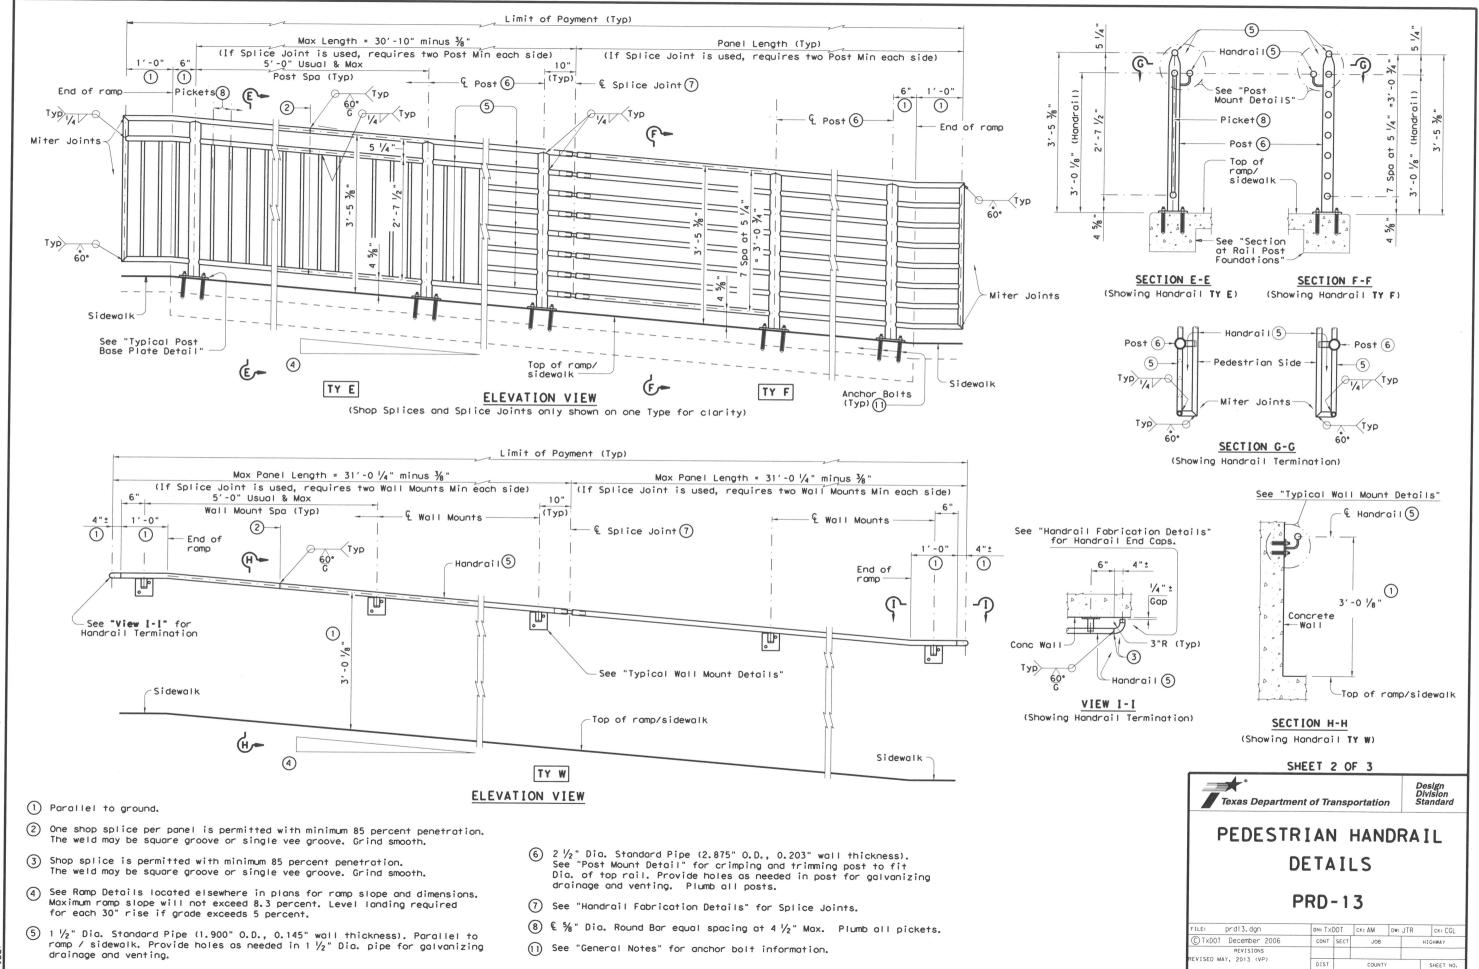

ATE:

TYPICAL POST BASE PLATE DETAIL

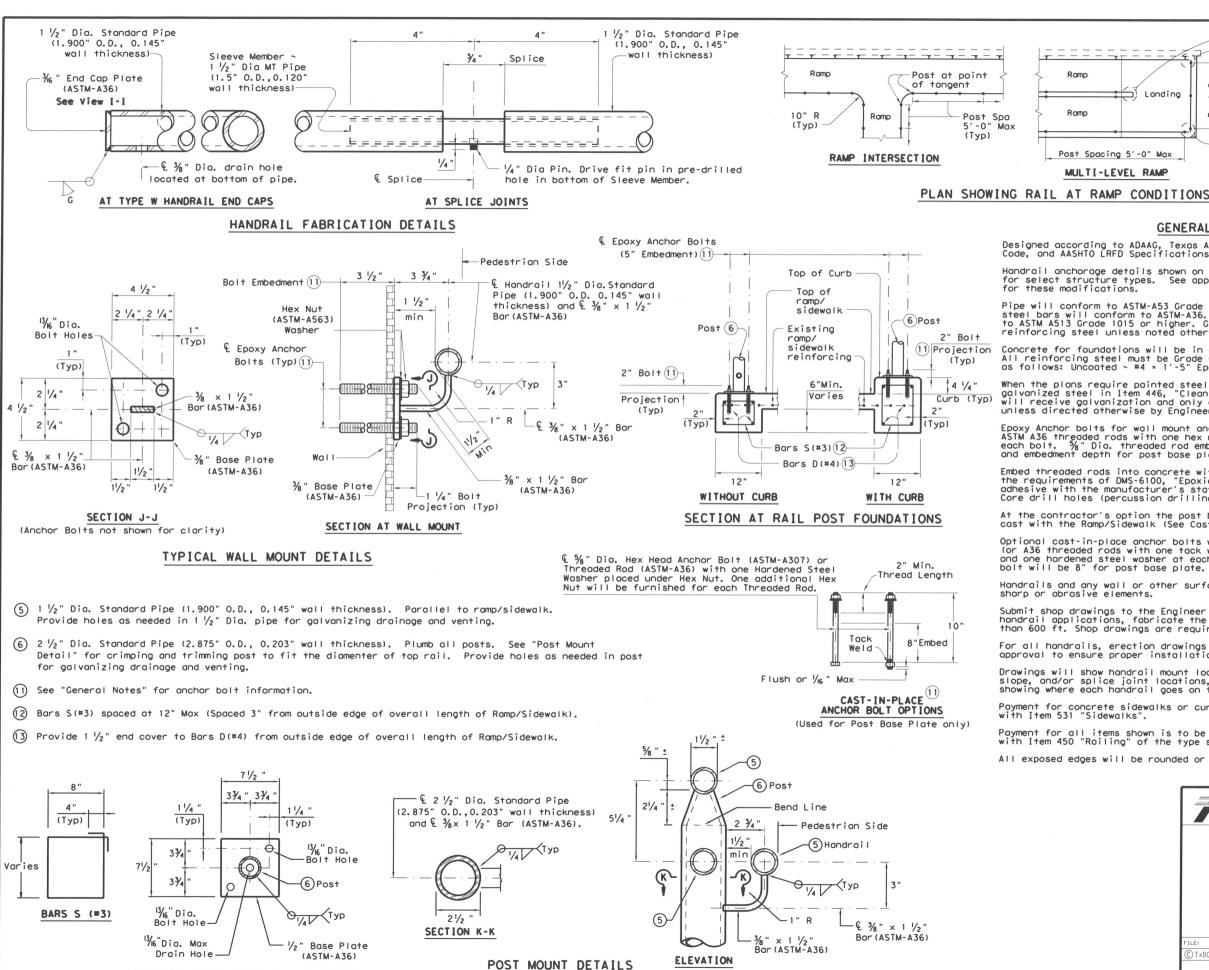

GENERAL NOTES

Landina

Ramp

Ramp

Post Spacing 5'-0" Max

MULTI-LEVEL RAMP

Designed according to ADAAG, Texas Accessibility Standards, Uniform Building Code, and AASHTO LRFD Specifications.

Max

Landing

Post Spacing 5'-0" Max

SINGLE-LEVEL RAMP

Continuous -

Handrail anchorage details shown on this standard may require modification for select structure types. See appropriate details elsewhere in plans for these modifications

Pipe will conform to ASTM-A53 Grade B or A500 Grade B. Steel plates and steel bars will conform to ASTM-A36. Mechanical tubing (MT) will conform to ASTM A513 Grade 1015 or higher. Galvanize all steel components except reinforcing steel unless noted otherwise.

Concrete for foundations will be in accordance with Item 531 "Sidewalks". All reinforcing steel must be Grade 60. Bar laps, where required, will be as follows: Uncoated \sim #4 = 1'-5" Epoxy coated \sim #4 = 2'-1"

When the plans require painted steel, follow the requirements for painting galvanized steel in Item 446, "Cleaning and Painting Steel". Sleeve Members will receive galvanization and only get field painted after installation unless directed otherwise by Engineer.

Epoxy Anchor bolts for wall mount and post base plate will be $\frac{5}{8}$ " Dia. ASTM A36 threaded rods with one hex nut and one hardened steel washer at each bolt. $\frac{5}{8}$ " Dia. threaded rod embedment depth for wall mounts is 3 $\frac{1}{2}$ " and embedment depth for post base plate is 5".

Embed threaded rods into concrete with a Type III (Class C) epoxy meeting the requirements of DMS-6100, "Epoxies and Adhesives". Mix and dispense adhesive with the manufacturer's static mixing nozzle/dual cartridge system. Core drill holes (percussion drilling not permitted).

At the contractor's option the post base plate anchor bolts may be cast with the Ramp/Sidewalk (See Cast-in-Place Anchor Bolt Options).

Optional cast-in-place anchor bolts will be $\frac{5}{8}$ " Dia ASTM A307 Grade A bolts (or A36 threaded rods with one tack welded hex nut each) with one hex nut and one hardened steel washer at each bolt. Embedment depth of cast-in-place

Handrails and any wall or other surface adjacent to them will be free of any sharp or abrasive elements.

Submit shop drawings to the Engineer unless otherwise noted. For curved handrail applications, fabricate the handrail to the curve if radius is less than 600 ft. Shop drawings are required when rail is fabricated to the curve.

For all handrails, erection drawings will be submitted to the Engineer for approval to ensure proper installation.

Drawings will show handrail mount locations with bolts setting, spacing, ramp slope, and/or splice joint locations, and handrail lengths with identification showing where each handrail goes on the layout.

Payment for concrete sidewalks or curb ramps will be paid for in accordance with Item 531 "Sidewalks".

Payment for all items shown is to be included in unit price bid in accordance with Item 450 "Railing" of the type specified.

All exposed edges will be rounded or chamfered to approximately $\frac{1}{8}$ by grinding.



SHEET 3 OF 3

PRD-13

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REVISED MAY, 2013 (VP)	DIST	COUNTY		Y	SHEET NO.	